


EXISTING FAR CALCULATIONS FOR:
96 WHEATLAND STREET, SOMERVILLE, MA


ZONED RB RESIDENCE B
FLOOR AREA RATIO: 10
LOT AREA: 4,000.00 SF
BASEMENT FLOOR GROSS SF: 1,127 SF
DEDUCTIONS
THE BASEMENT IS UNFINISHED SPACE
FIRST FLOOR GROSS SF: 1,384.8 SF
DEDUCTIONS
STAIRS 90.9 SF
CLOSETS 42.9 SF
FIRST FLOOR AREA NET: 1,251.4 SF
SECOND FLOOR GROSS SF: 1,130 SF
DEDUCTIONS
STAIRS 101.4 SF
CLOSETS 21.9 SF
SECOND FLOOR AREA NET: 1,006.1 SF
THIRD FLOOR GROSS SF: 1,130 SF
DEDUCTIONS
STAIRS 100.8 SF
CLOSETS 21.9 SF
THIRD FLOOR AREA NET: 1,007.3 SF
TOTAL NET SF
BASEMENT: UNFINISHED -N/A
FIRST FLOOR: 1,251.4 SF
SECOND FLOOR: 1,006.1 SF
THIRD FLOOR: 1,007.3 SF
BUILDING TOTAL NET SF: 3,265.4 SF
FAR: 0.8164

CONCRETE SURFACES: 1,432.1 SF 36% LOT COVERAGE
PERVIOUS LANDSCAPE: 1,156.1 SF 29% LOT COVERAGE
BUILDING FOOTPRINT: 1,384.8 SF 35% LOT COVERAGE
FRONT CONCRETE STEPS: 26.4 SF LESS THAN 1%

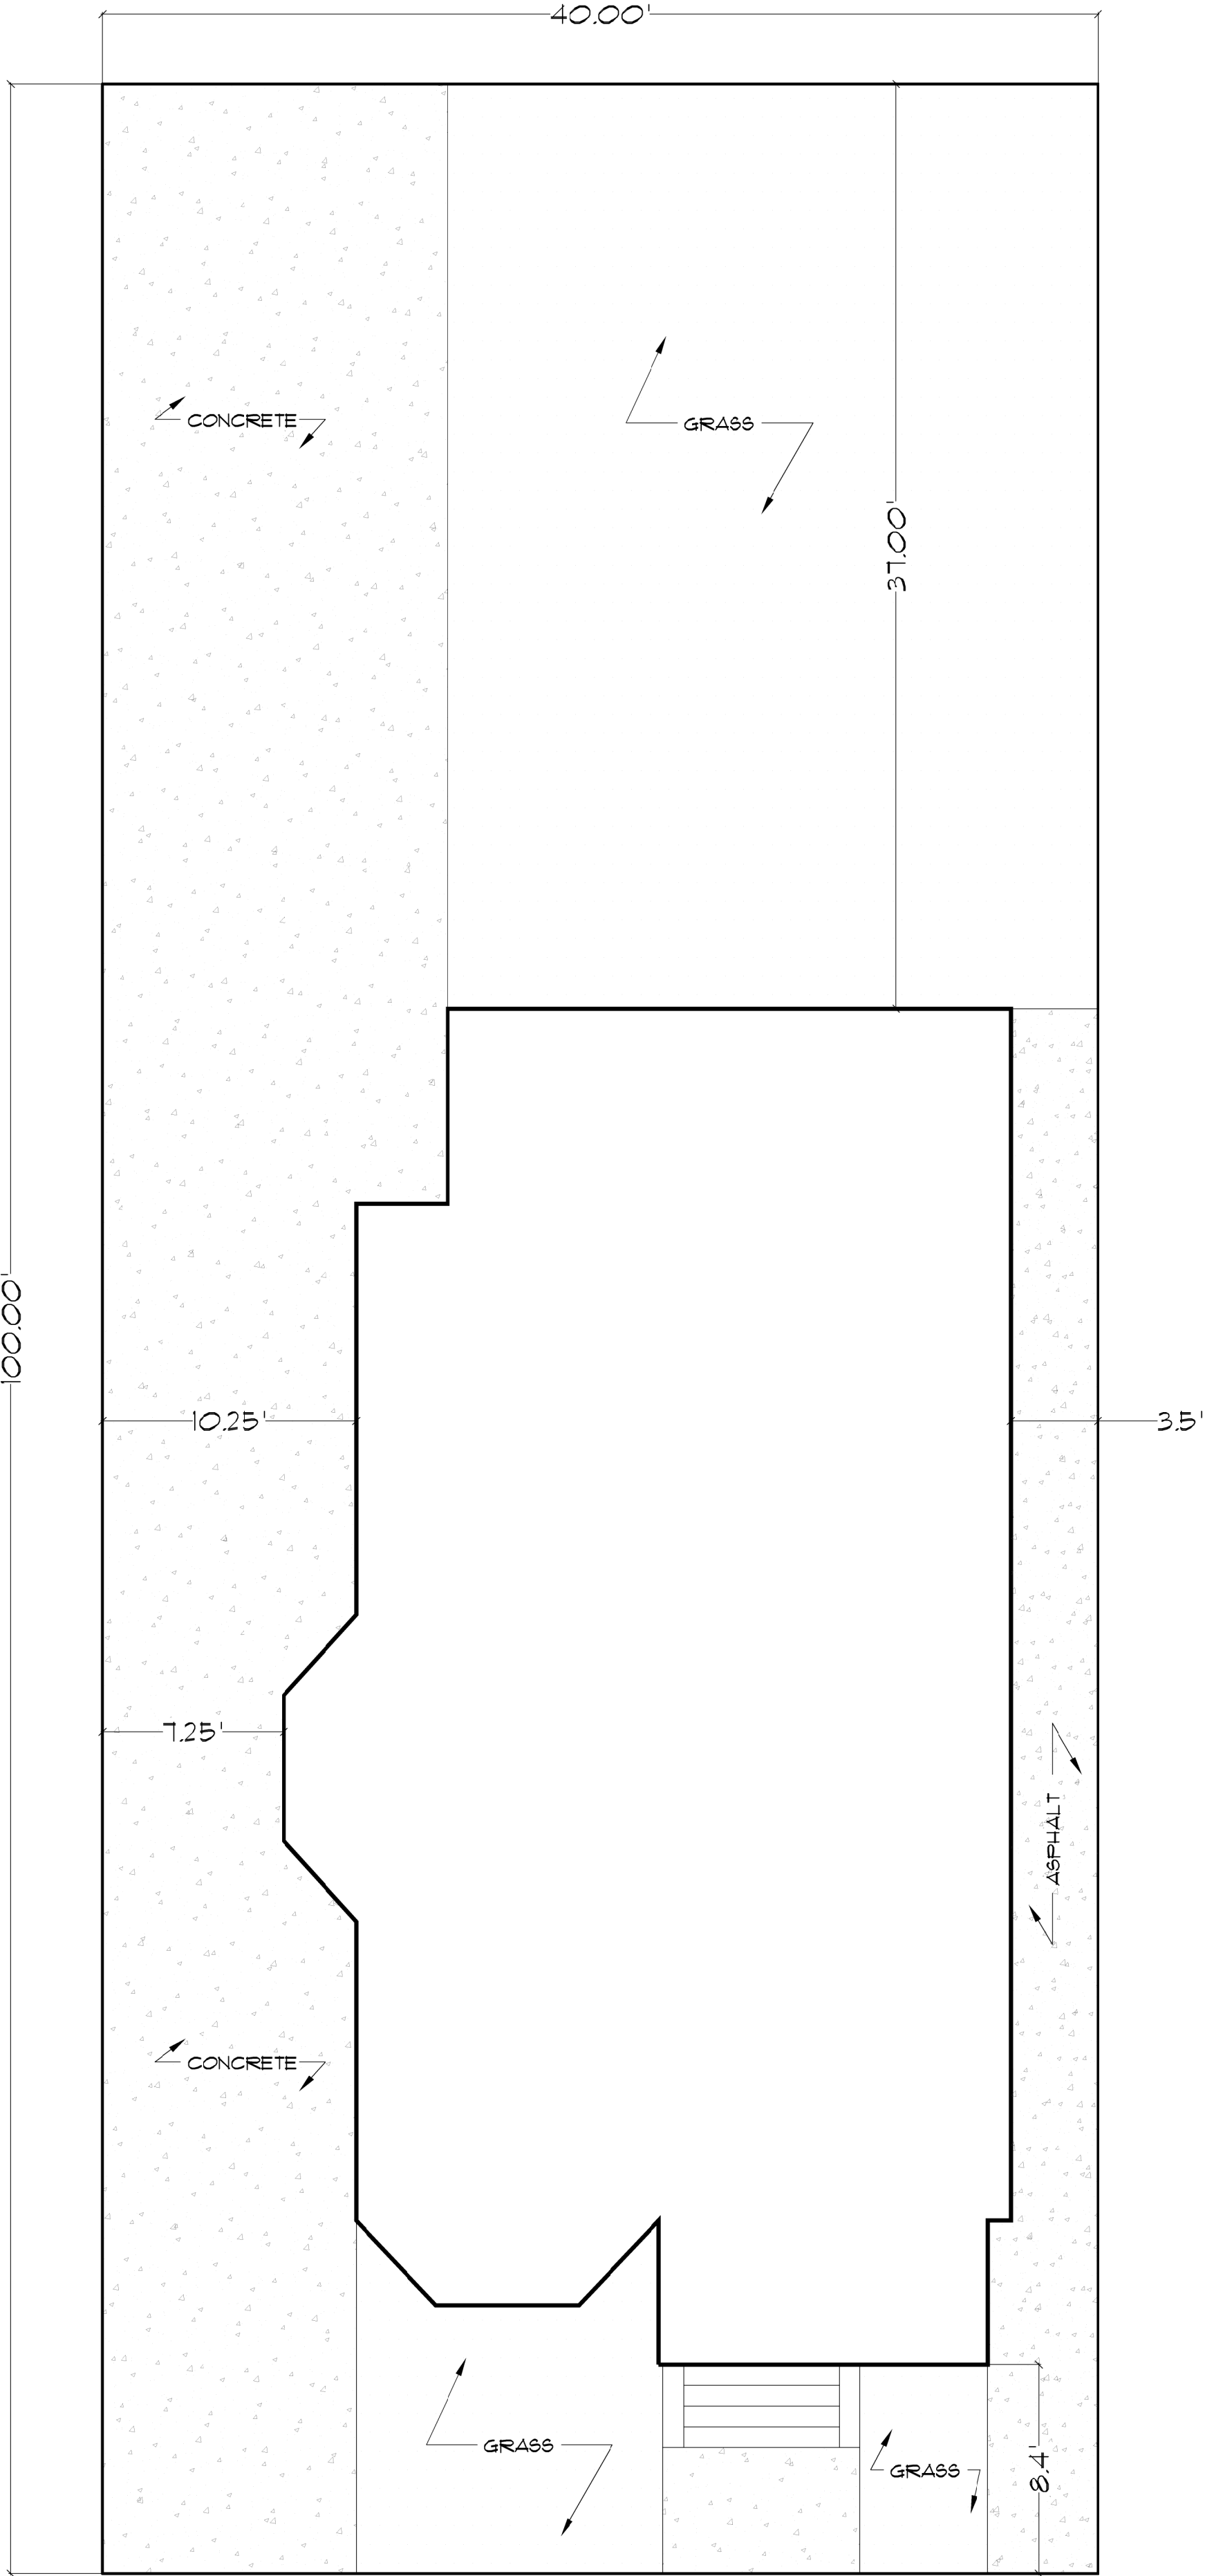

WHEATLAND STREET

EXISTING SITE PLAN
SCALE: 3/16" = 1'-0"

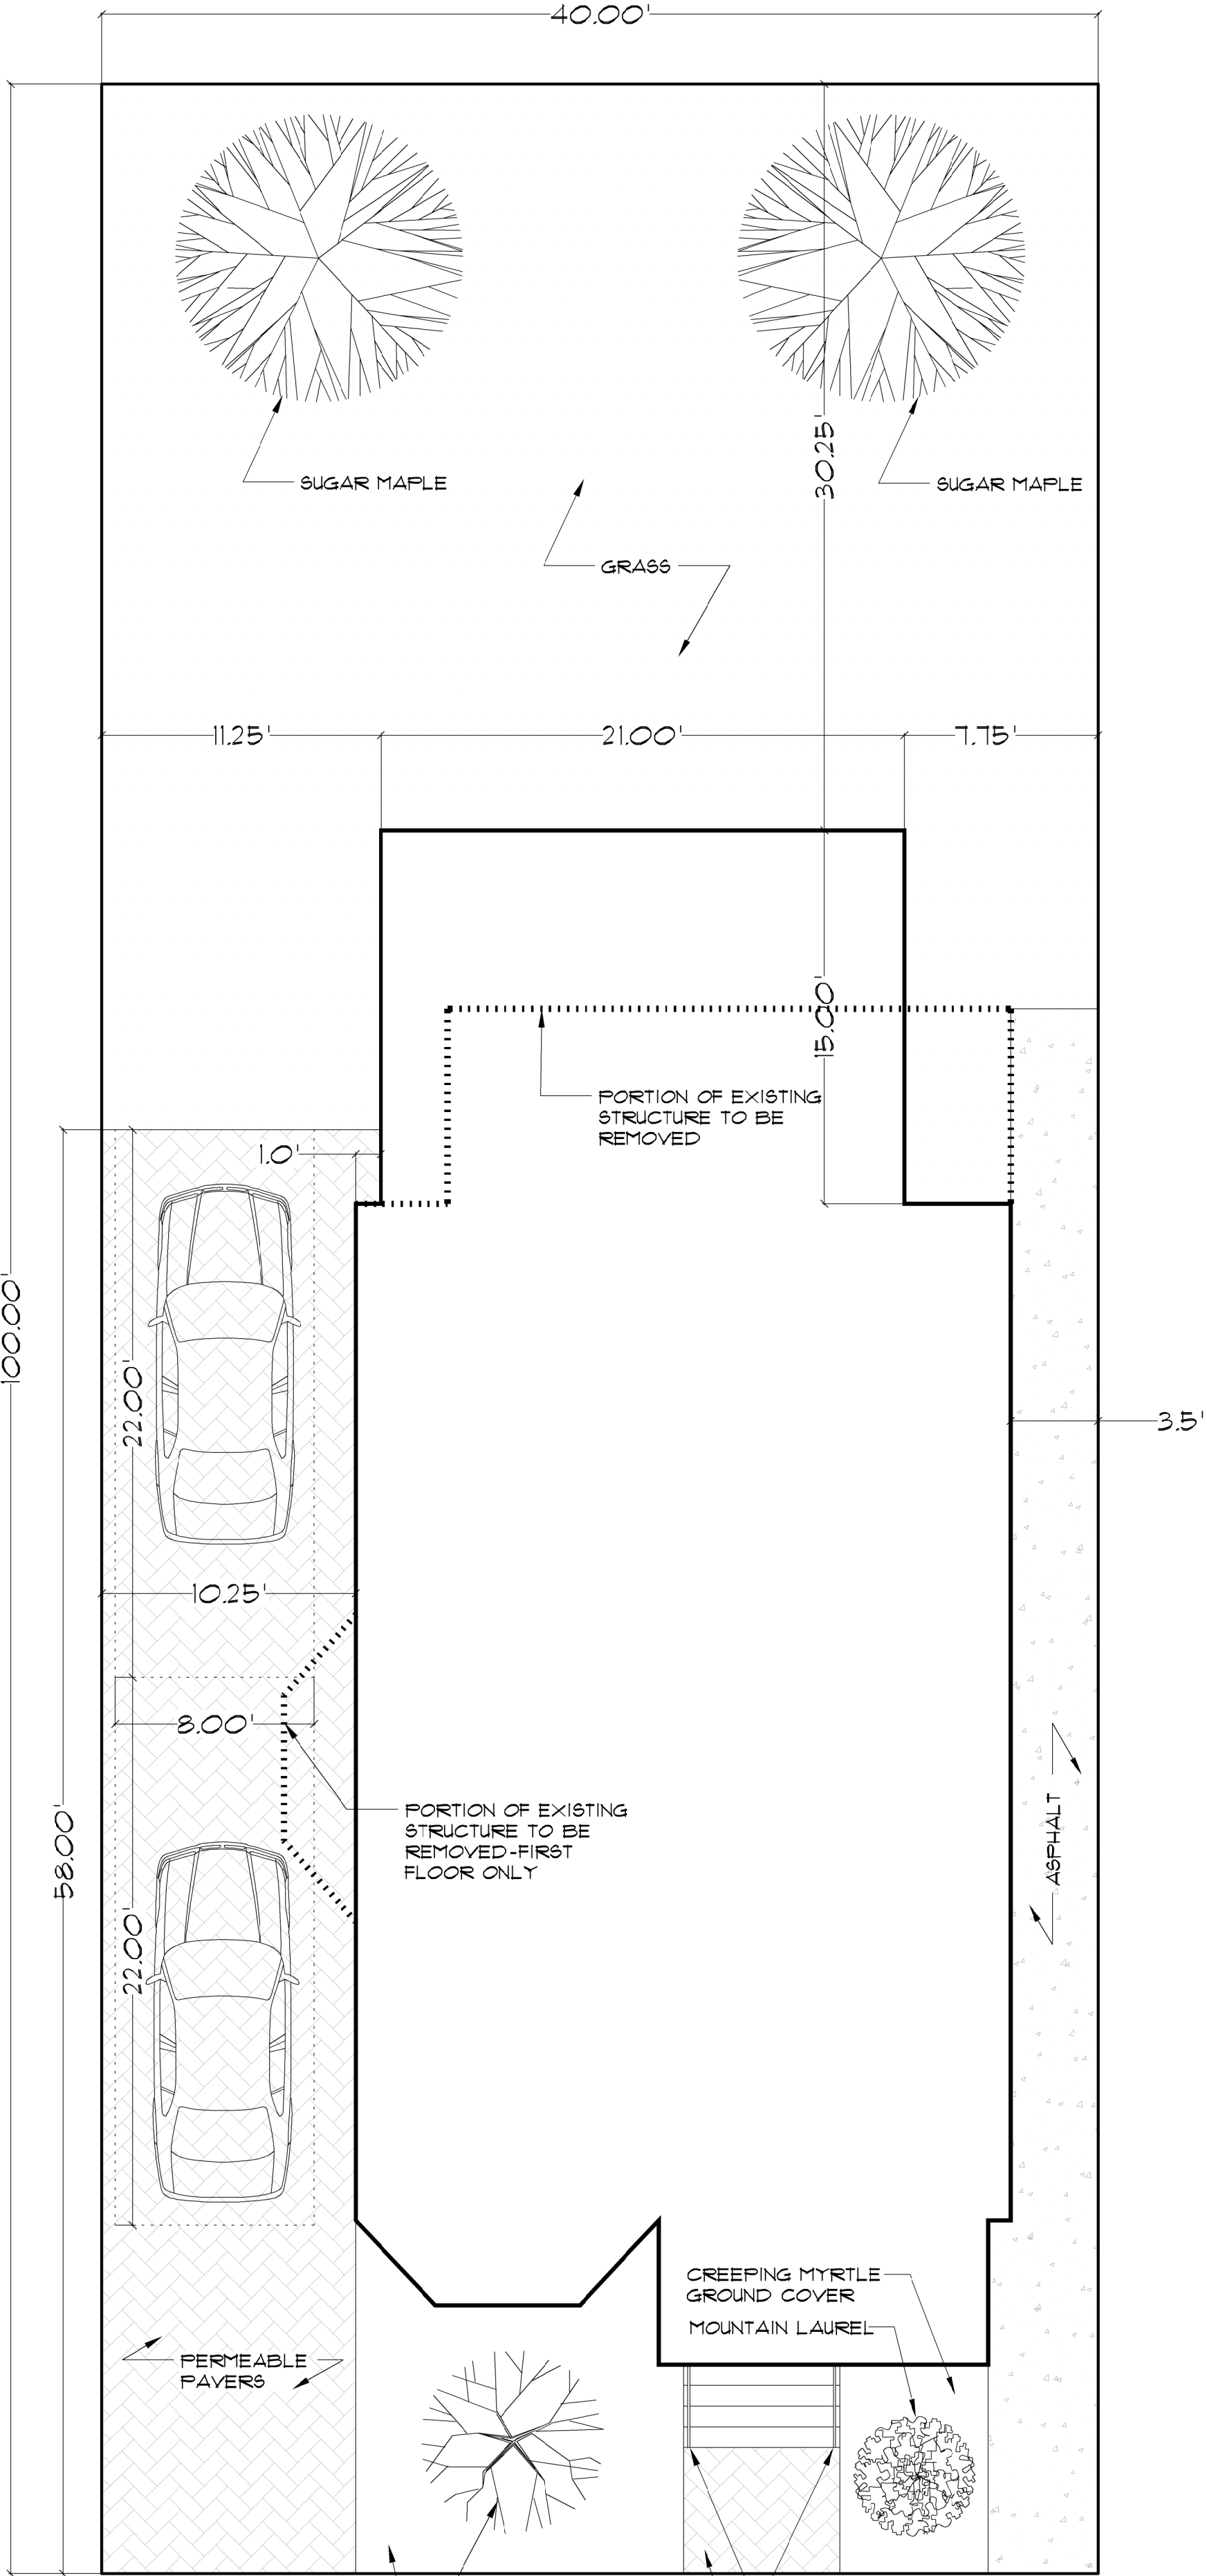

PROPOSED SITE PLAN
SCALE: 3/16" = 1'-0"

FAR CALCULATIONS FOR:
96 WHEATLAND STREET, SOMERVILLE, MA

ZONED RB RESIDENCE B
FLOOR AREA RATIO: 10
LOT AREA: 4,000.00 SF
BASEMENT FLOOR GROSS SF: 1,094 SF
DEDUCTIONS
THE BASEMENT IS UNFINISHED SPACE
FIRST FLOOR GROSS SF: 1,409 SF
DEDUCTIONS
STAIRS 90.9 SF
CLOSETS 72.1 SF
FIRST FLOOR AREA NET: 1,246 SF
SECOND FLOOR GROSS SF: 1,445 SF
DEDUCTIONS
STAIRS 101.4 SF
CLOSETS 55 SF
SECOND FLOOR AREA NET: 1,288.6 SF
THIRD FLOOR GROSS SF: 1,445 SF
DEDUCTIONS
STAIRS 100.8 SF
CLOSETS 55 SF
THIRD FLOOR AREA NET: 1,289.2 SF
TOTAL NET SF
BASEMENT: UNFINISHED -N/A
FIRST FLOOR: 1,246 SF
SECOND FLOOR: 1,288.6 SF
THIRD FLOOR: 1,289.2 SF
BUILDING TOTAL NET SF: 3,823.8 SF
FAR: 0.9553

ASPHALT: 233.5 SF 6% LOT COVERAGE
PERVIOUS LANDSCAPE: 1,623.9 SF 41% LOT COVERAGE
PERMEABLE PAVERS: 625.1 SF 16% LOT COVERAGE
BUILDING FOOTPRINT: 1,436 SF 37% LOT COVERAGE
FRONT STONE STEPS: 20.9 SF LESS THAN 1%

NOTE:
THESE DRAWINGS HAVE BEEN CREATED
BY REFERENCING THE SURVEY
PREPARED BY SCOTT CERRATO,
PROFESSIONAL LAND SURVEYOR ON
5/15/18

PLAN NORTH

REVISIONS

BY

SCALE: 3/16" = 1'-0"
OR AS NOTED

DRAWN BY:

M.R.L.

CHK'D BY:

R.H.T.

DATE:

5-30-19

ROBERT THERRIEN, ARCHITECT

249 AYER RD HARVARD, MA 01451

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OR IN PART WITHOUT THE WRITTEN EXPRESS CONSENT OF ROBERT THERRIEN.

TITLE:
SITE PLANS & FAR CALCULATIONS

ADDITION & RENOVATION


96 WHEATLAND ST.
SOMERVILLE, MA

COMMISSION NO.


R021219

Sheet

S-1

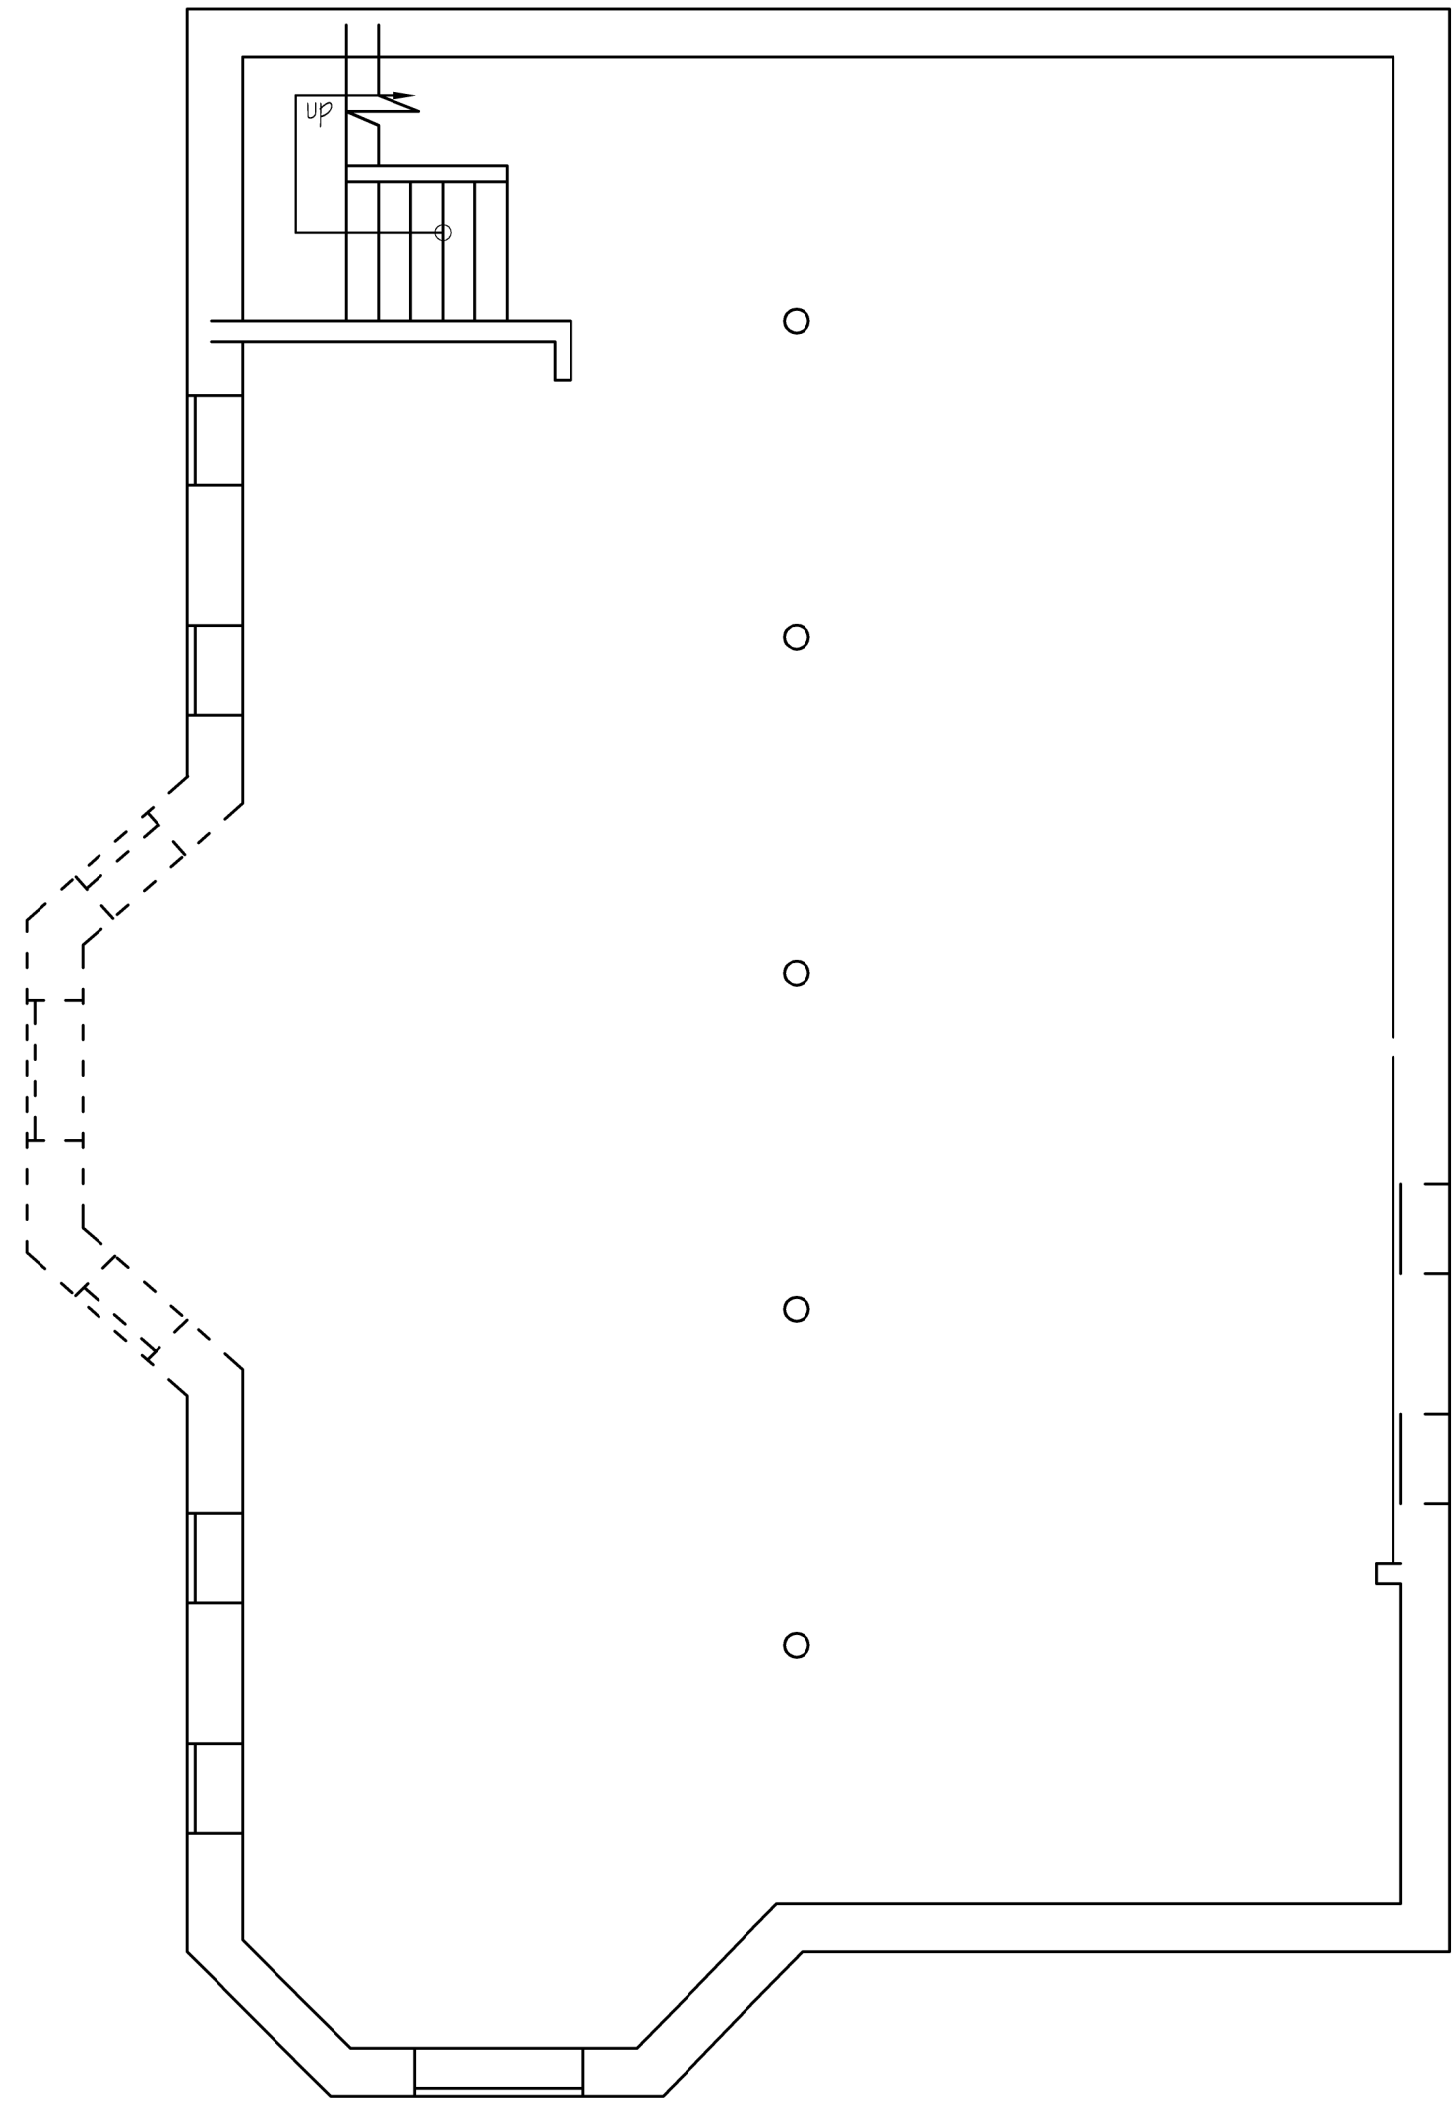

EXISTING BASEMENT PLAN

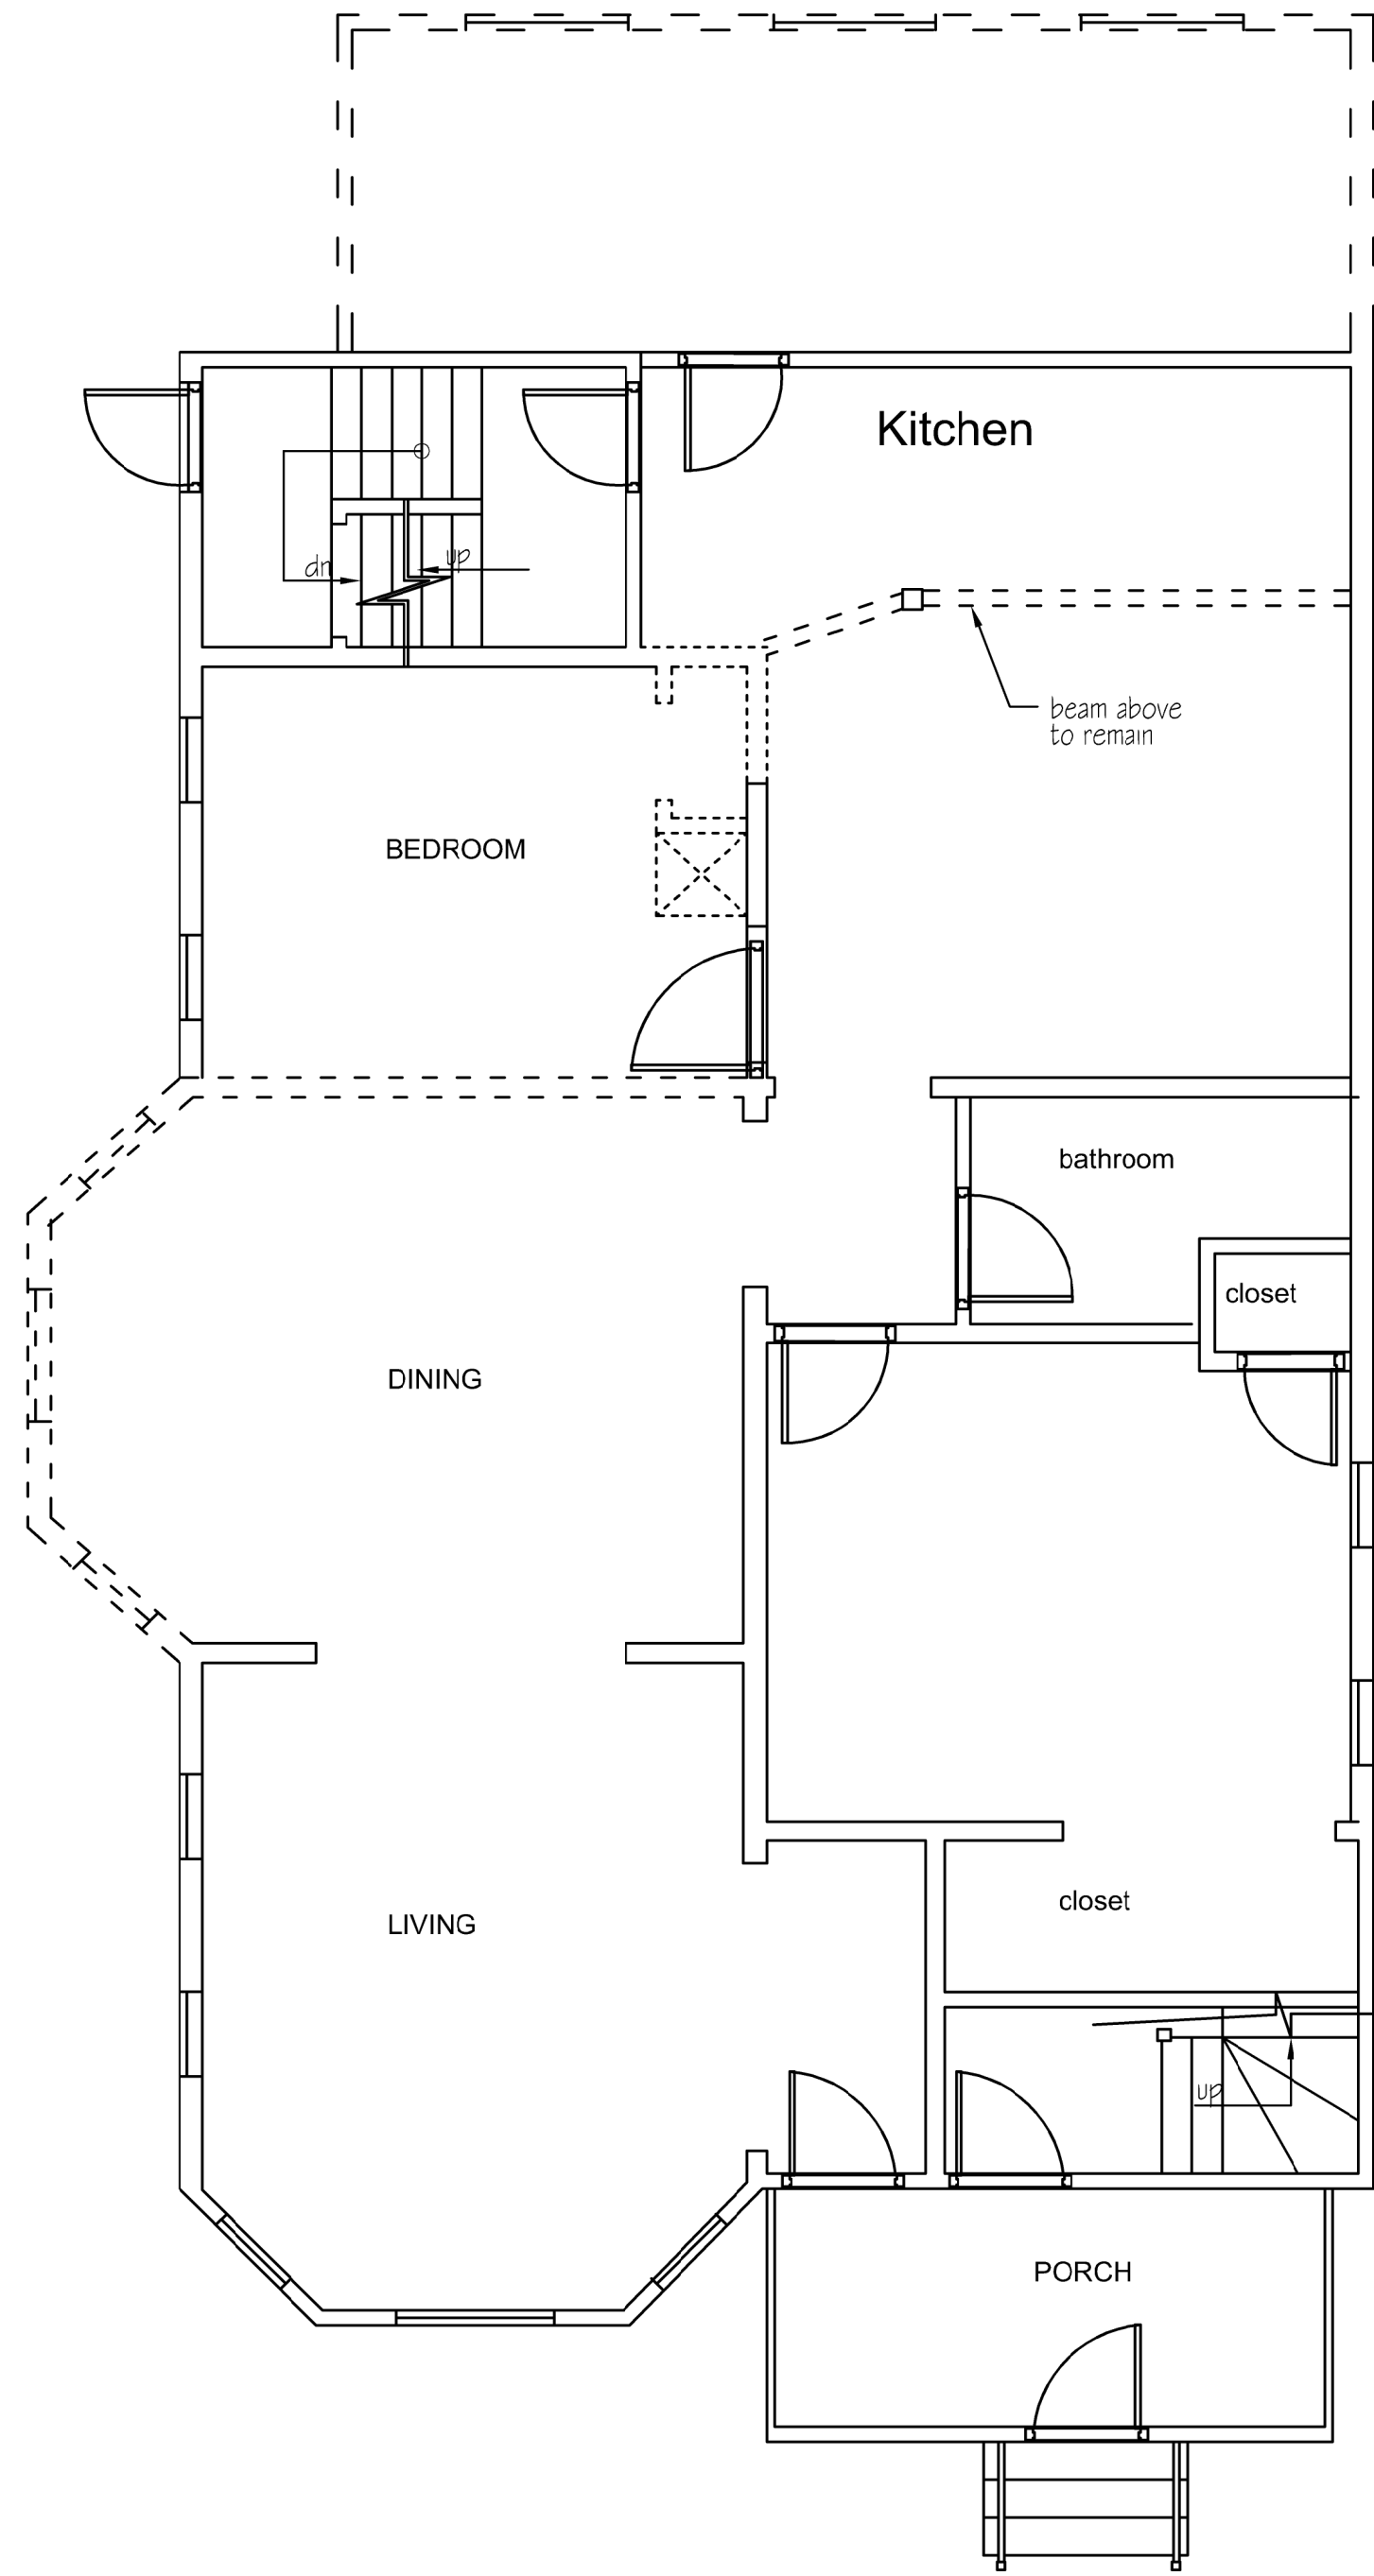

EXISTING FIRST FLOOR PLAN

LEGEND

- — — — — EXISTING WALL
- - - - - WALL TO BE REMOVED

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TITLE:
EXISTING PLANS


ADDITION & INTERIOR RENOVATION

96 WHEATLAND ST.
SOMERVILLE, MA


COMMISSION NO.
C041019

Sheet
EX1

SCALE: 1/4" = 1'-0" OR AS NOTED	BY	REVISIONS			
DRAWN BY: M.R.L.					
CHK'D BY: R.H.T.					
DATE: 5.30.19					

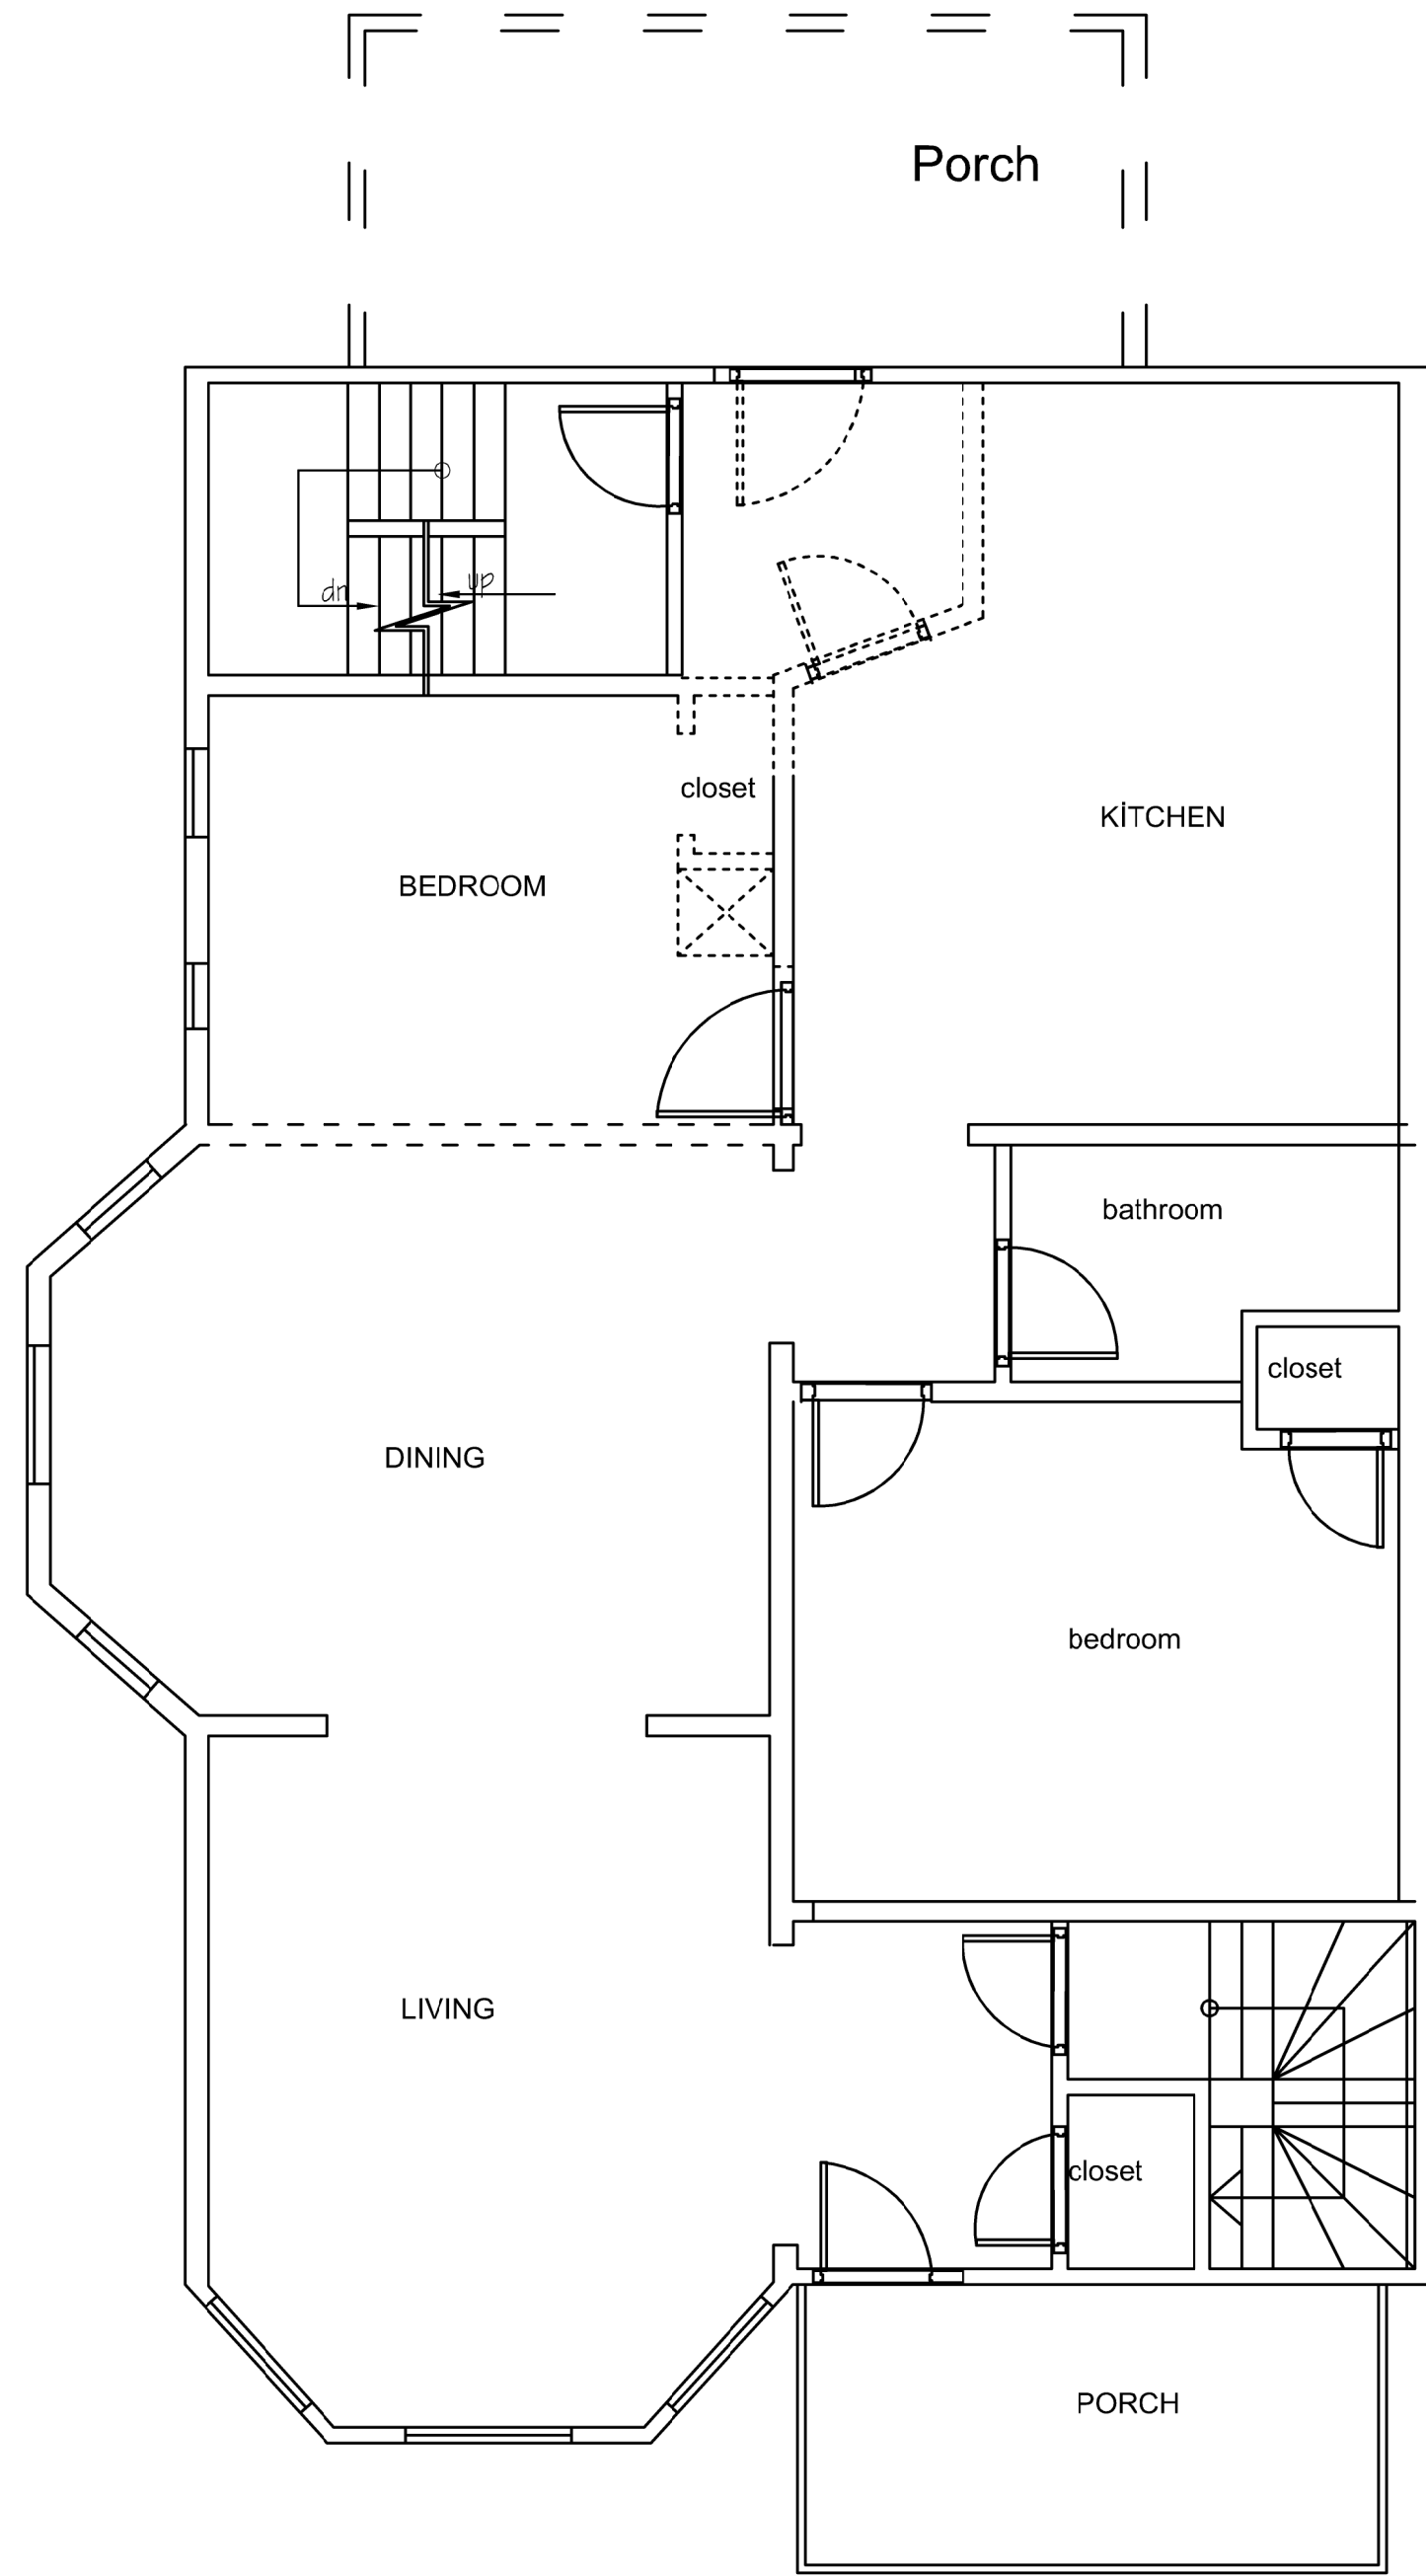

EXISTING SECOND FLOOR PLAN

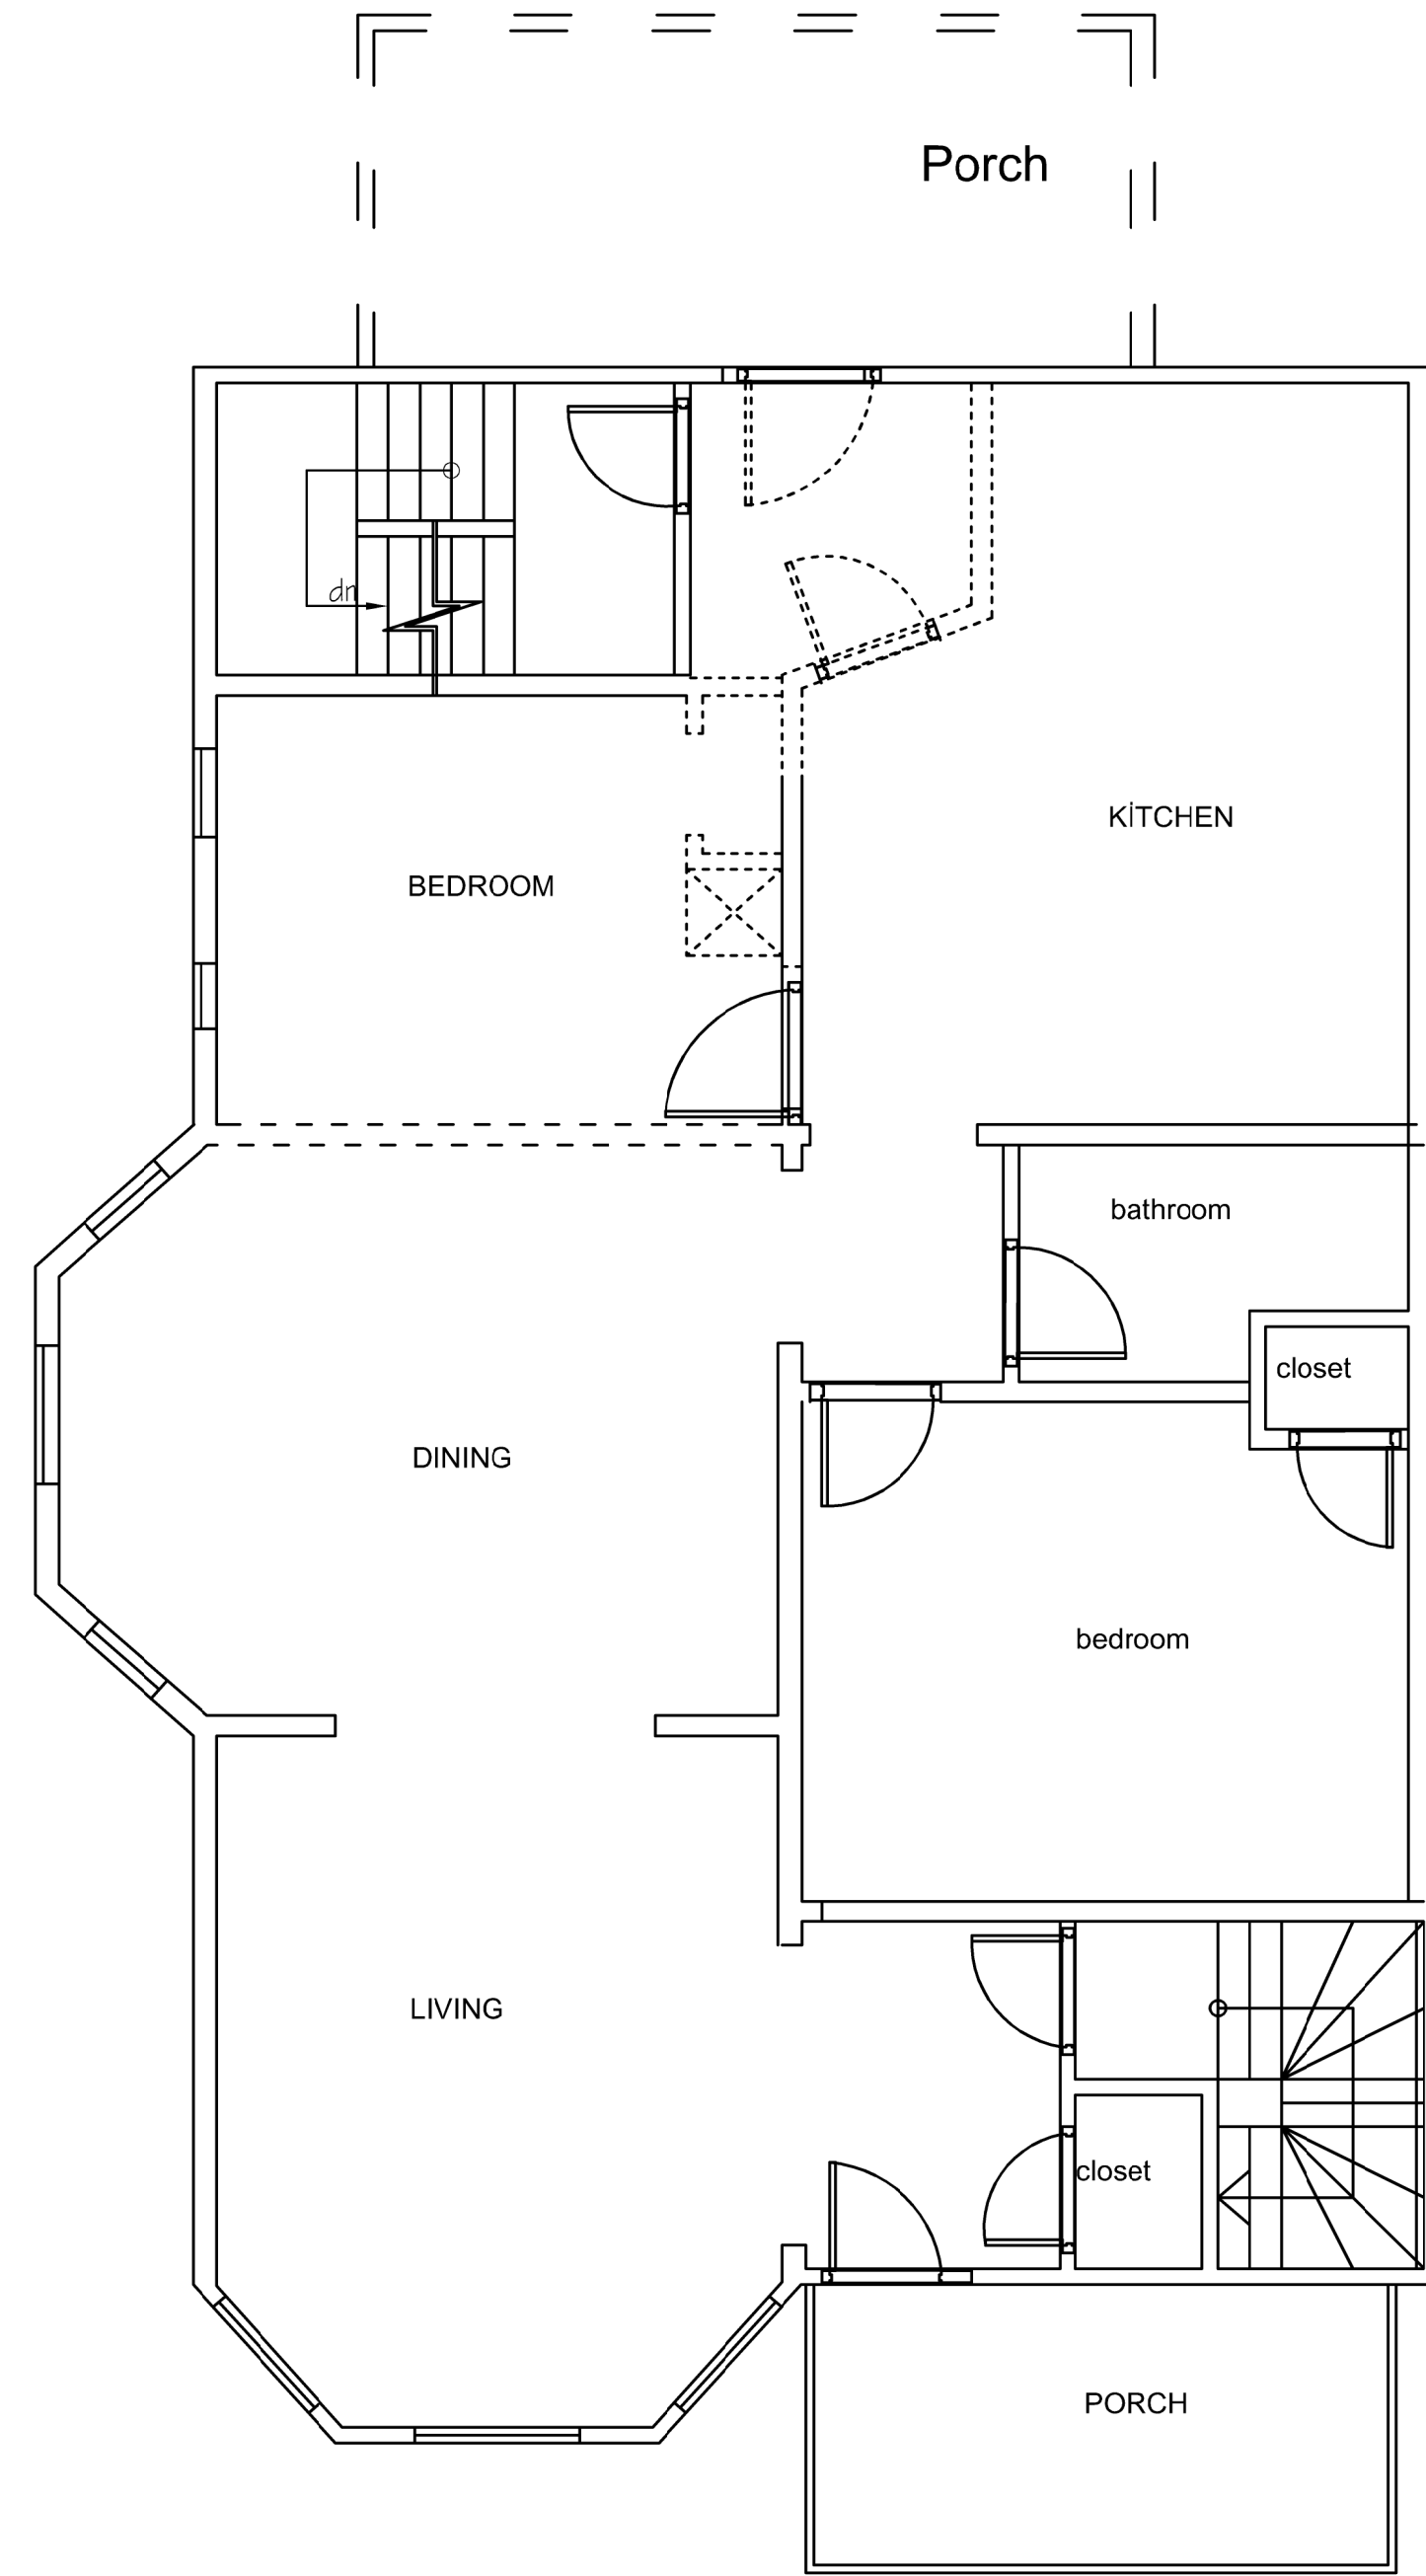


EXISTING THIRD FLOOR PLAN

TITLE:
EXISTING PLANS

COMMISSION NO.
C041019

Sheet
EX2

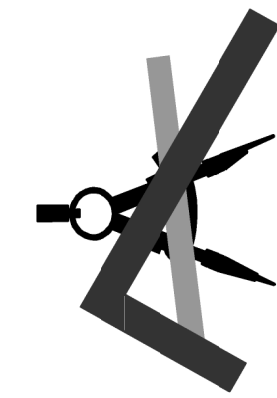

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ADDITION INTERIOR RENOVATION

96 WHEATLAND ST.
SOMERVILLE, MA

REVISIONS

BY

SCALE:
1/4" = 1'-0"
OR AS NOTED

DRAWN BY:
M.R.L.

CHK'D BY:
R.H.T.

DATE:
4/25/19

FORTE SOLUTIONS REPORT Level, Floor: Flush Beam PASSED
Current Solution: : 2 piece(s) 1 3/4" x 9 1/4" 2.0E Microllam® LVL
 Overall Length: 10' 7"

All locations are measured from the outside face of left support (or left cantilever end). All dimensions are horizontal; Drawing is Conceptual

Design Results	Actual @ Location	Allowed	Result	LDF	
Member Reaction (lbs)	2746 @ 2"	5709 (2,254)	Passed (48%)	--	System : Floor
Shear (lbs)	2239 @ 1' 3/4"	6151	Passed (36%)	1.00	Member Type : Flush Beam
Moment (Ft-lbs)	6953 @ 5' 3 1/2"	11204	Passed (62%)	1.00	Building Use : Residential
Live Load Defl. (in)	0.228 @ 5' 3 1/2"	0.342	Passed (L/539)	--	Building Code : IRC 2015
Total Load Defl. (in)	0.310 @ 5' 3 1/2"	0.342	Passed (L/397)	--	Design Methodology : ASD

System : Floor
Member Type : Flush Beam
Building Use : Residential
Building Code : IBC 2015
Design Methodology : ASD

All Product Solutions			
Depth	Series	Piles	Wood Volume
9 1/4"	1 3/4" 2.0E Microllam® LVL	2	64.75

The purpose of this report is for product comparison only. Load and support information necessary for professional design review is not displayed here. Please print an individual Member Report for submittal purposes.

Forfe Software Operator	Job Notes
Matthew Lawrence Robert Thierien Architects (978) 391-1230 matlawrence131@gmail.com	96 WHEATLAND ST SOMERVILLE, MA

4/11/2019 9:31:18 AM
Forte v5.4, Design Engine: V7.1.1.3

Page 1 of 1

☐ SMOKE DETECTOR
☐ CARBON MONOXIDE DETECTOR

NEW 2X4 STUD WALL @ 16" O.C.


EXISTING WALL

GENERAL NOTES:

1. CONTRACTOR TO VERIFY ALL DIMENSIONS PRIOR TO COMMENCING ANY NEW CONSTRUCTION.
2. CONTRACTOR SHALL VERIFY FLOOR TO FLOOR HEIGHTS PRIOR TO COMMENCING CONSTRUCTION.
3. CONTRACTOR SHALL REPORT ALL DISCREPANCIES TO "THE ARCHITECT FOR INSTRUCTION".
4. ALL WORK TO BE EXECUTED IN ACCORDANCE WITH STATE AND LOCAL CODES AND INDUSTRY STANDARD PRACTICES.
5. INSULATION REQUIREMENTS WERE PREPARED IN ACCORDANCE WITH STATE BUILDING CODE, MANY COMMUNITIES HAVE INCREASED THESE REQUIREMENTS BY ADOPTING "ENERGY STRETCH CODE", CHECK WITH ARCHITECT FOR ANY CHANGES TO THESE REQUIREMENTS, EXCEPTIONS, AND WAIVERS.

ARCHITECT'S NOTES:

1. THESE DRAWINGS WERE PREPARED FOR BUILDING PERMIT PURPOSES.
2. OTHER BUILDING SYSTEMS SUCH AS: MECHANICAL, ELECTRICAL, PLUMBING, EXTERIOR FINISHES, HANDRAIL, WINDOW & ROOFING SHALL BE SELECTED BY THE OWNER.
3. ALL OWNER SELECTED SYSTEMS SHALL BE INSTALLED PER MANUFACTURER'S SPECIFICATIONS & COORDINATED WITH THESE DRAWINGS.

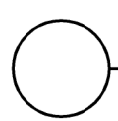

- ⑤ SMOKE DETECTOR
- ⑥ CARBON MONOXIDE DETECTOR
- ⑦ EXHAUST FAN

STAIR REQUIREMENTS

- ALL STAIRWELLS SHALL HAVE (2) LAYERS OF
5/8" FC GYPSUM WALL BOARD

ALL BEDROOM WINDOWS SHALL HAVE
EGRESSABLE WINDOWS

EGRESS WINDOW REQUIREMENTS:


1. Min opening width 20"
2. Min. opening height 24"
3. Min. clear opening 5.7 sf
4. Max Sill Height 44" above floor

DOOR SIZE REQUIREMENTS-6'-8"H

EGRESS DOORS: I SHALL BE 36" WIDE, THE SECOND MEANS OF EGRESS MAY BE A MINIMUM OF 32" WIDE.

BEDROOM DOORS: MINIMUM 30"


BATHROOM & CLOSET: MINIMUM 28

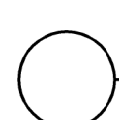

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PROPOSED BASEMENT & FIRST FLOOR

MISSION NO.
C041019

Sheet


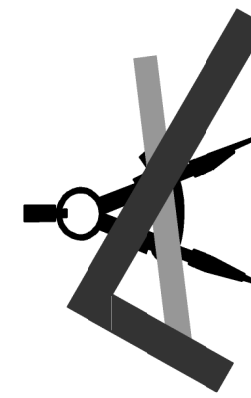
A1

SCALE: 1/4" = 1'-0"	BY	REVISIONS
DRAWN BY: MRL		
CHECKED BY: RHT		
DATE: 5/30/14		

GENERAL NOTES:
1. CONTRACTOR TO VERIFY ALL DIMENSIONS PRIOR TO COMMENCING ANY NEW CONSTRUCTION.
2. CONTRACTOR SHALL VERIFY FLOOR TO FLOOR HEIGHTS PRIOR TO COMMENCING CONSTRUCTION.
3. CONTRACTOR SHALL REPORT ANY DISCREPANCIES TO THE ARCHITECT FOR INSTRUCTION.
4. ALL WORK TO BE EXECUTED IN ACCORDANCE WITH STATE AND LOCAL CODES AND INDUSTRY STANDARD CONSTRUCTION REQUIREMENTS.
5. INSULATION REQUIREMENTS WERE PREPARED IN ACCORDANCE WITH STATE BUILDING CODE. MANY COMMUNITIES HAVE INCREASED THESE REQUIREMENTS BY ADOPTING "ENERGY STRETCH CODE". CHECK WITH LOCAL BUILDING DEPARTMENT REGARDING THESE REQUIREMENTS, EXCEPTIONS, AND WAIVER'S.

ARCHITECT'S NOTES:
1. THESE DRAWINGS WERE PREPARED FOR BUILDING PERMIT PURPOSES.
2. OTHER BUILDING SYSTEMS SUCH AS: MECHANICAL, ELECTRICAL, PLUMBING, EXTERIOR FINISHES, HANDRAIL, WINDOW & ROOFING SHALL BE SELECTED BY THE OWNER.
3. ALL OWNER SELECTED SYSTEMS SHALL BE INSTALLED PER MANUFACTURER'S SPECIFICATIONS & COORDINATED WITH THESE DRAWINGS.

NEW 36"X60" H EGRESSABLE WINDOWS TYPICAL ON NEW ADDITION-MATCH EXISTING HEADER HEIGHT ON EXISTING STRUCTURE

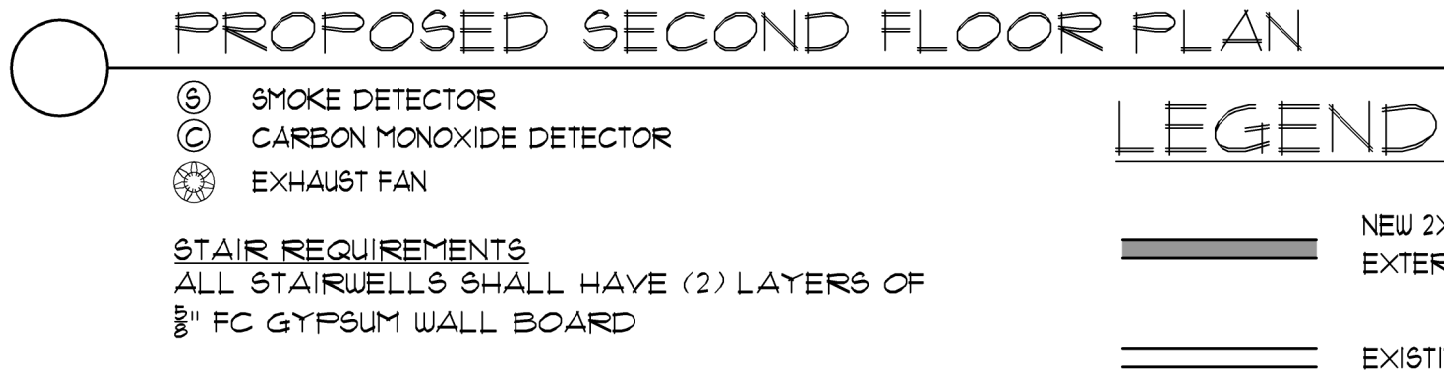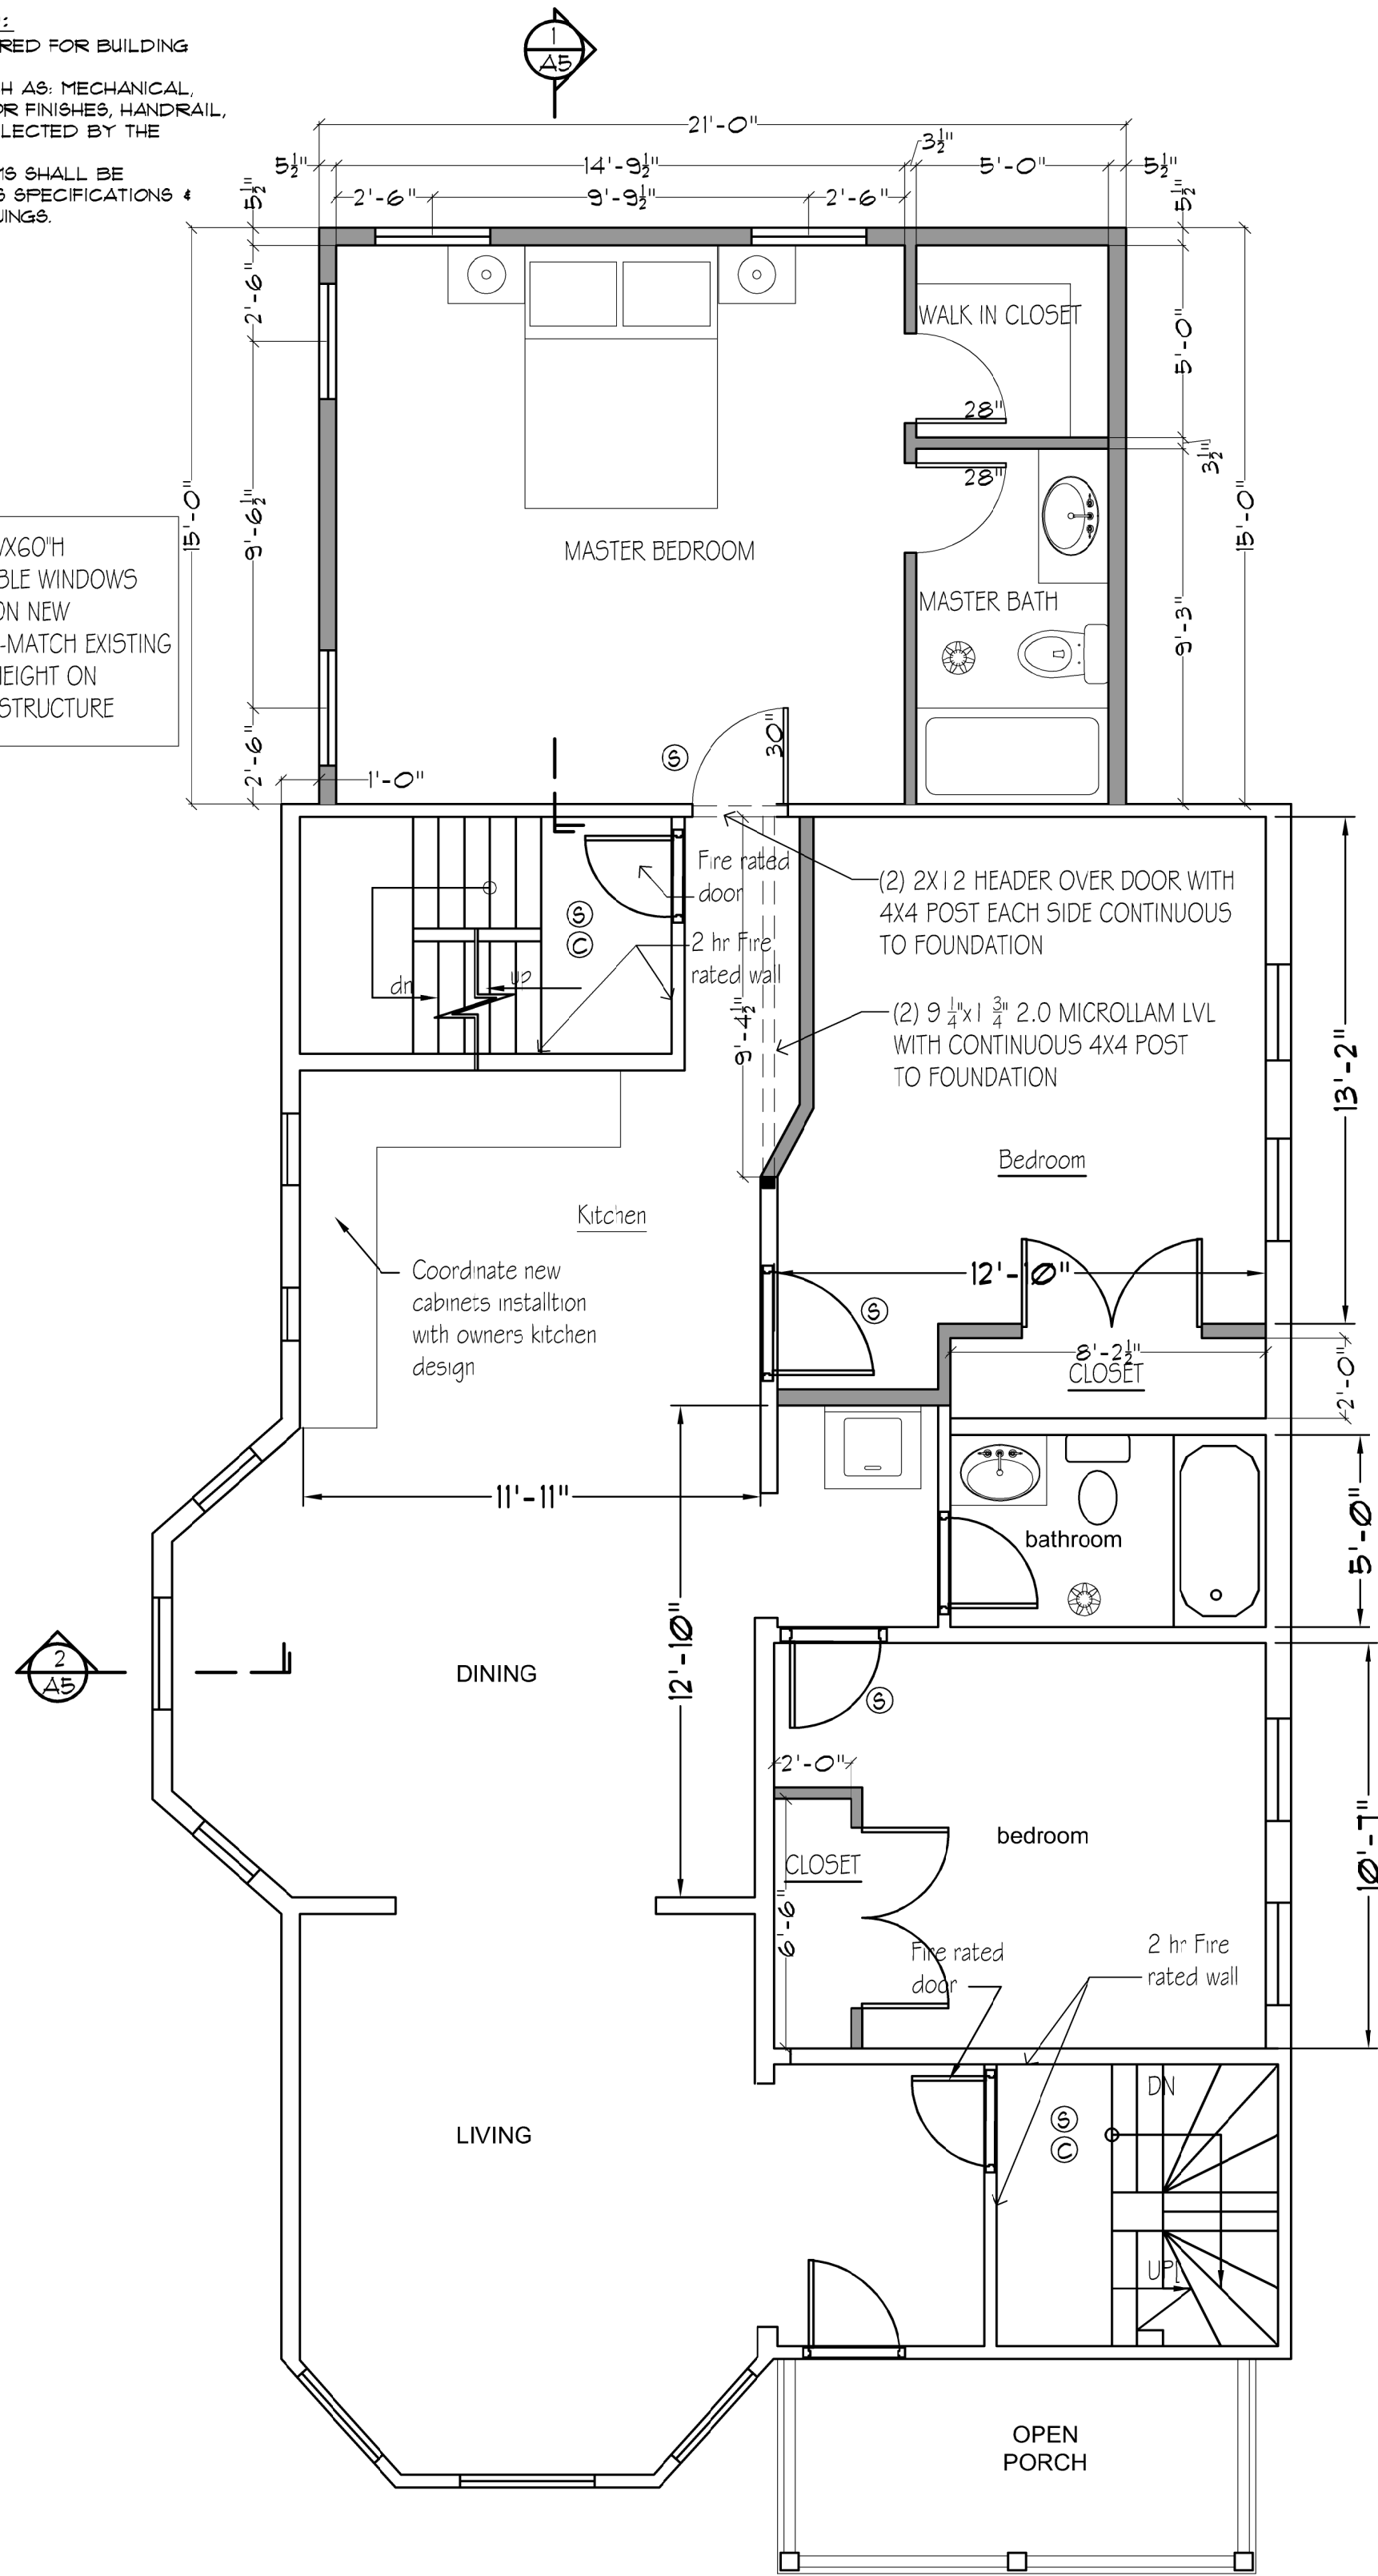


DOOR SIZE REQUIREMENTS-6'-8" H

EGRESS DOORS: 1 SHALL BE 36" WIDE, THE SECOND MEANS OF EGRESS MAY BE A MINIMUM OF 32" WIDE.

BEDROOM DOORS: MINIMUM 30"

BATHROOM & CLOSET: MINIMUM 28"


NEW 36"X60" H EGRESSABLE WINDOWS TYPICAL ON NEW ADDITION-MATCH EXISTING HEADER HEIGHT ON EXISTING STRUCTURE

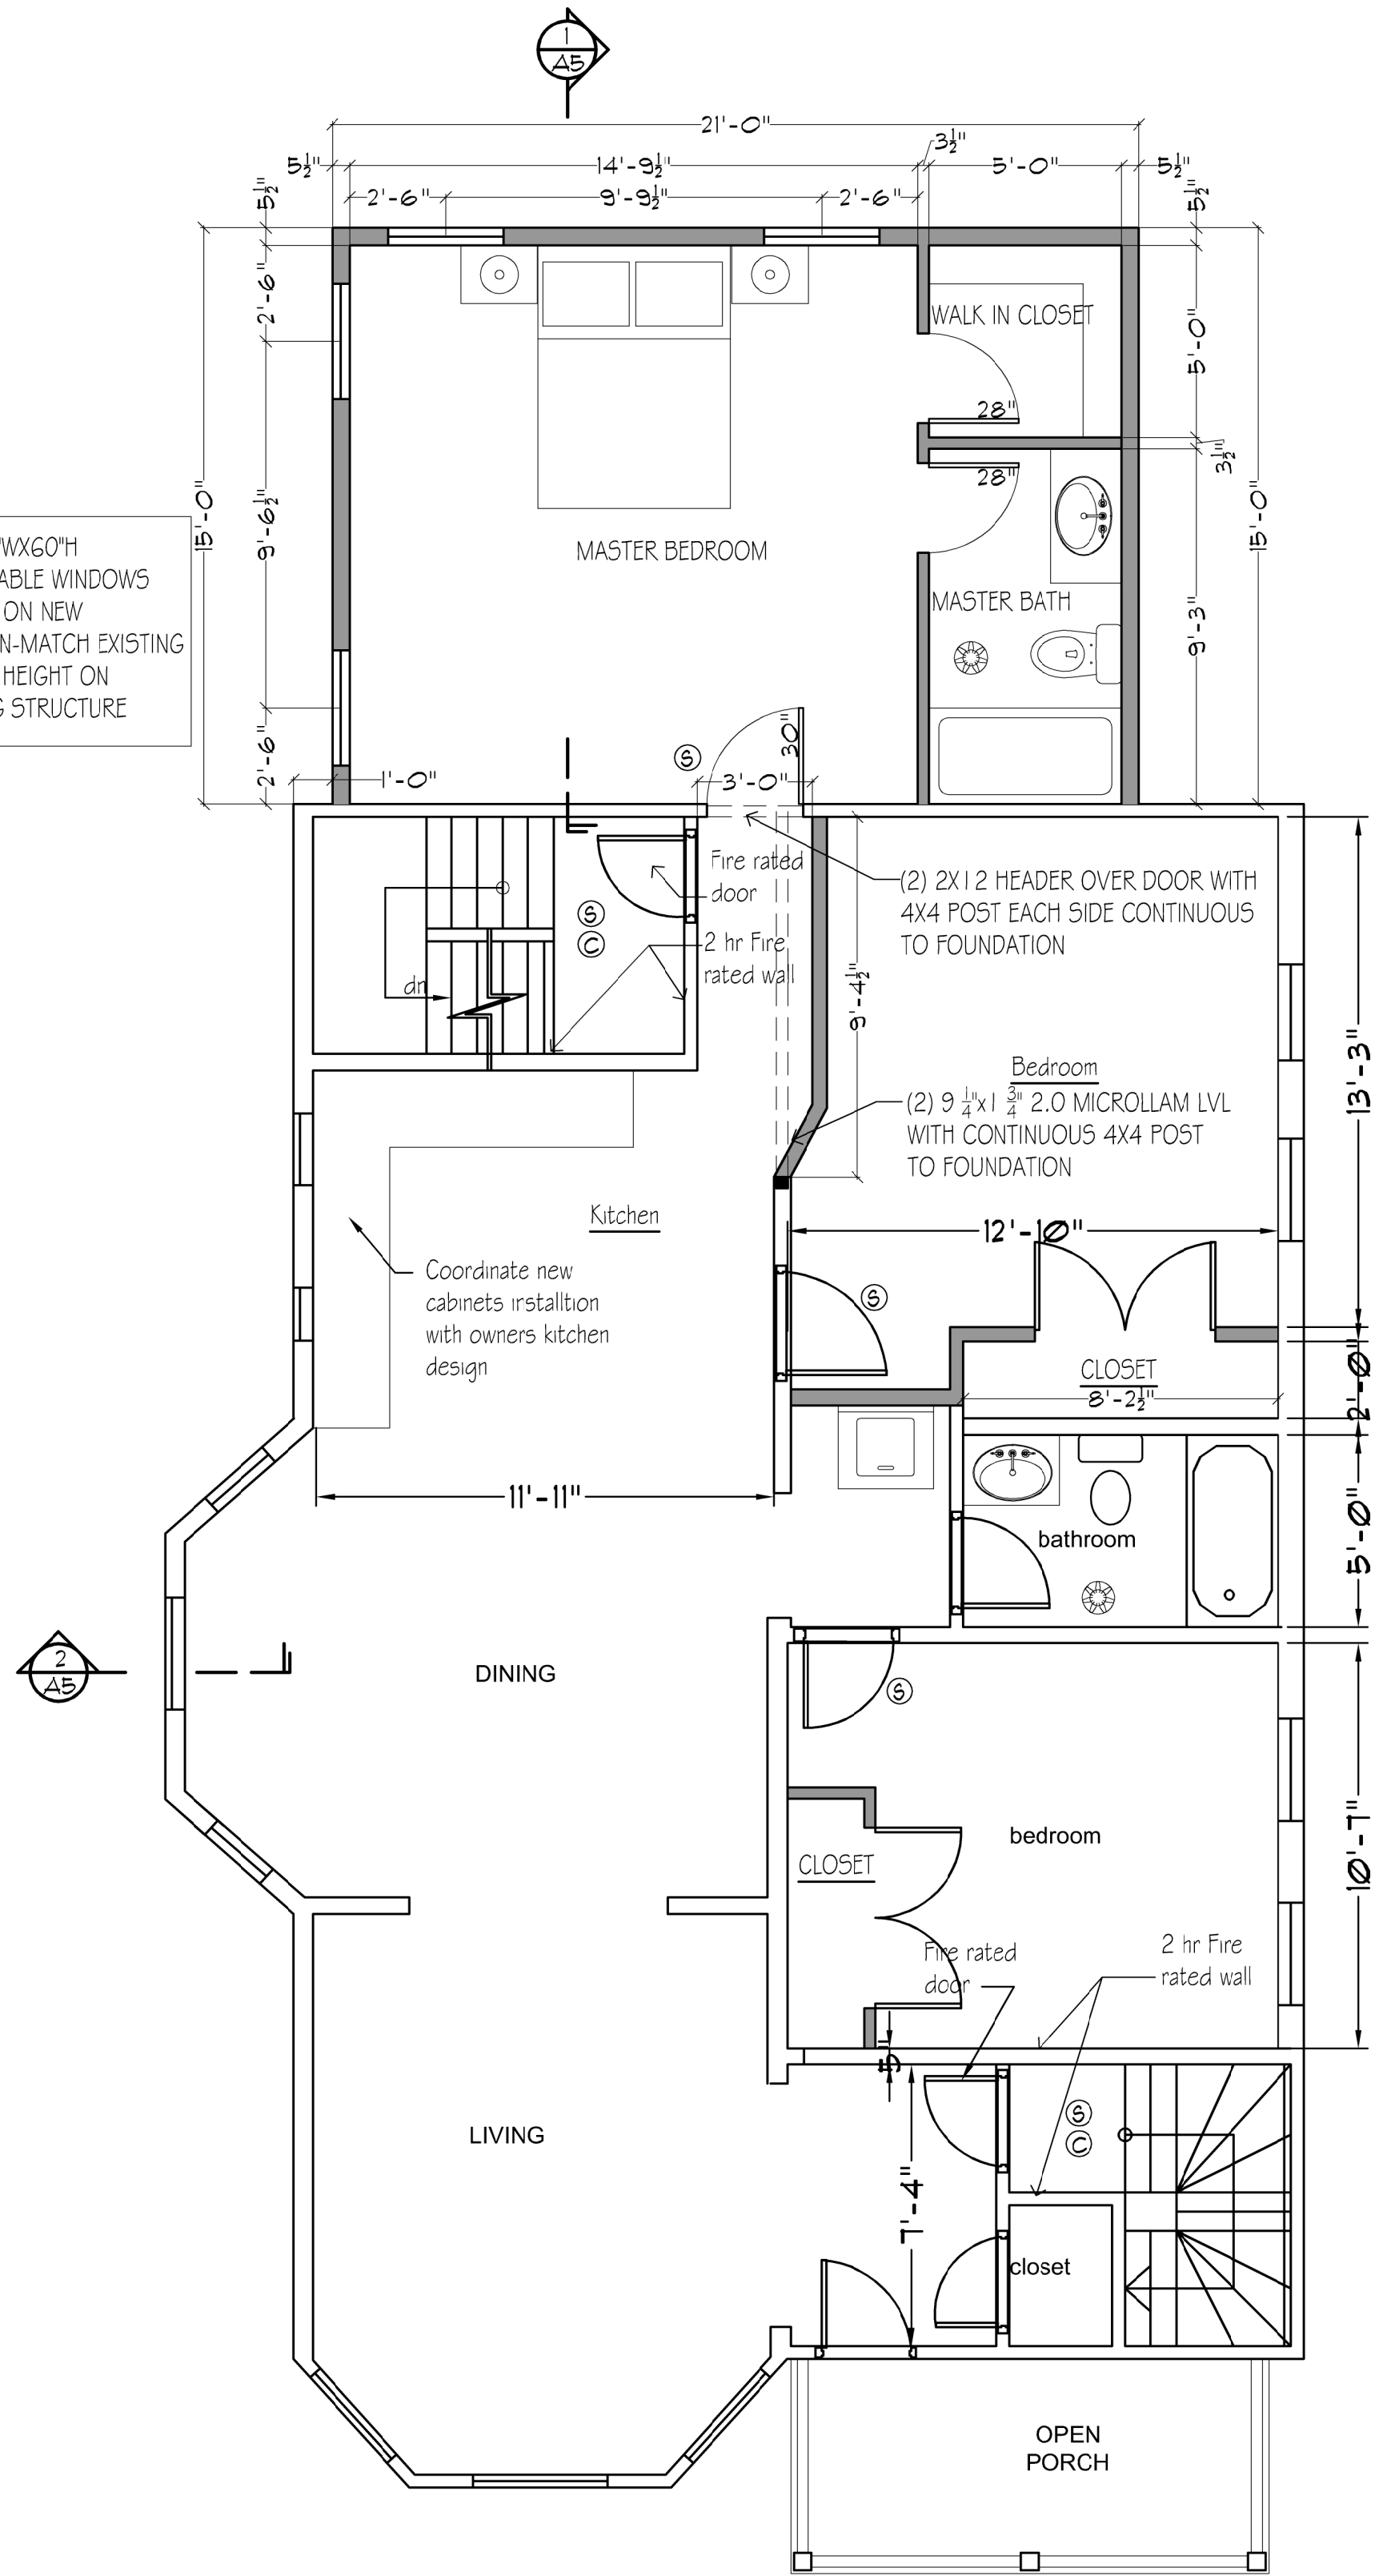


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TITLE: PROPOSED SECOND & THIRD FLOOR PLANS	REVISIONS	
	BY	
COMMISSION NO. C041019	SCALE: 1/4"=1'-0" OR AS NOTED	DRAWN BY: M.R.L.
		CHECKED BY: R.H.T.
	DATE: 5-30-19	
	SHEET A2	



EXISTING LEFT ELEVATION

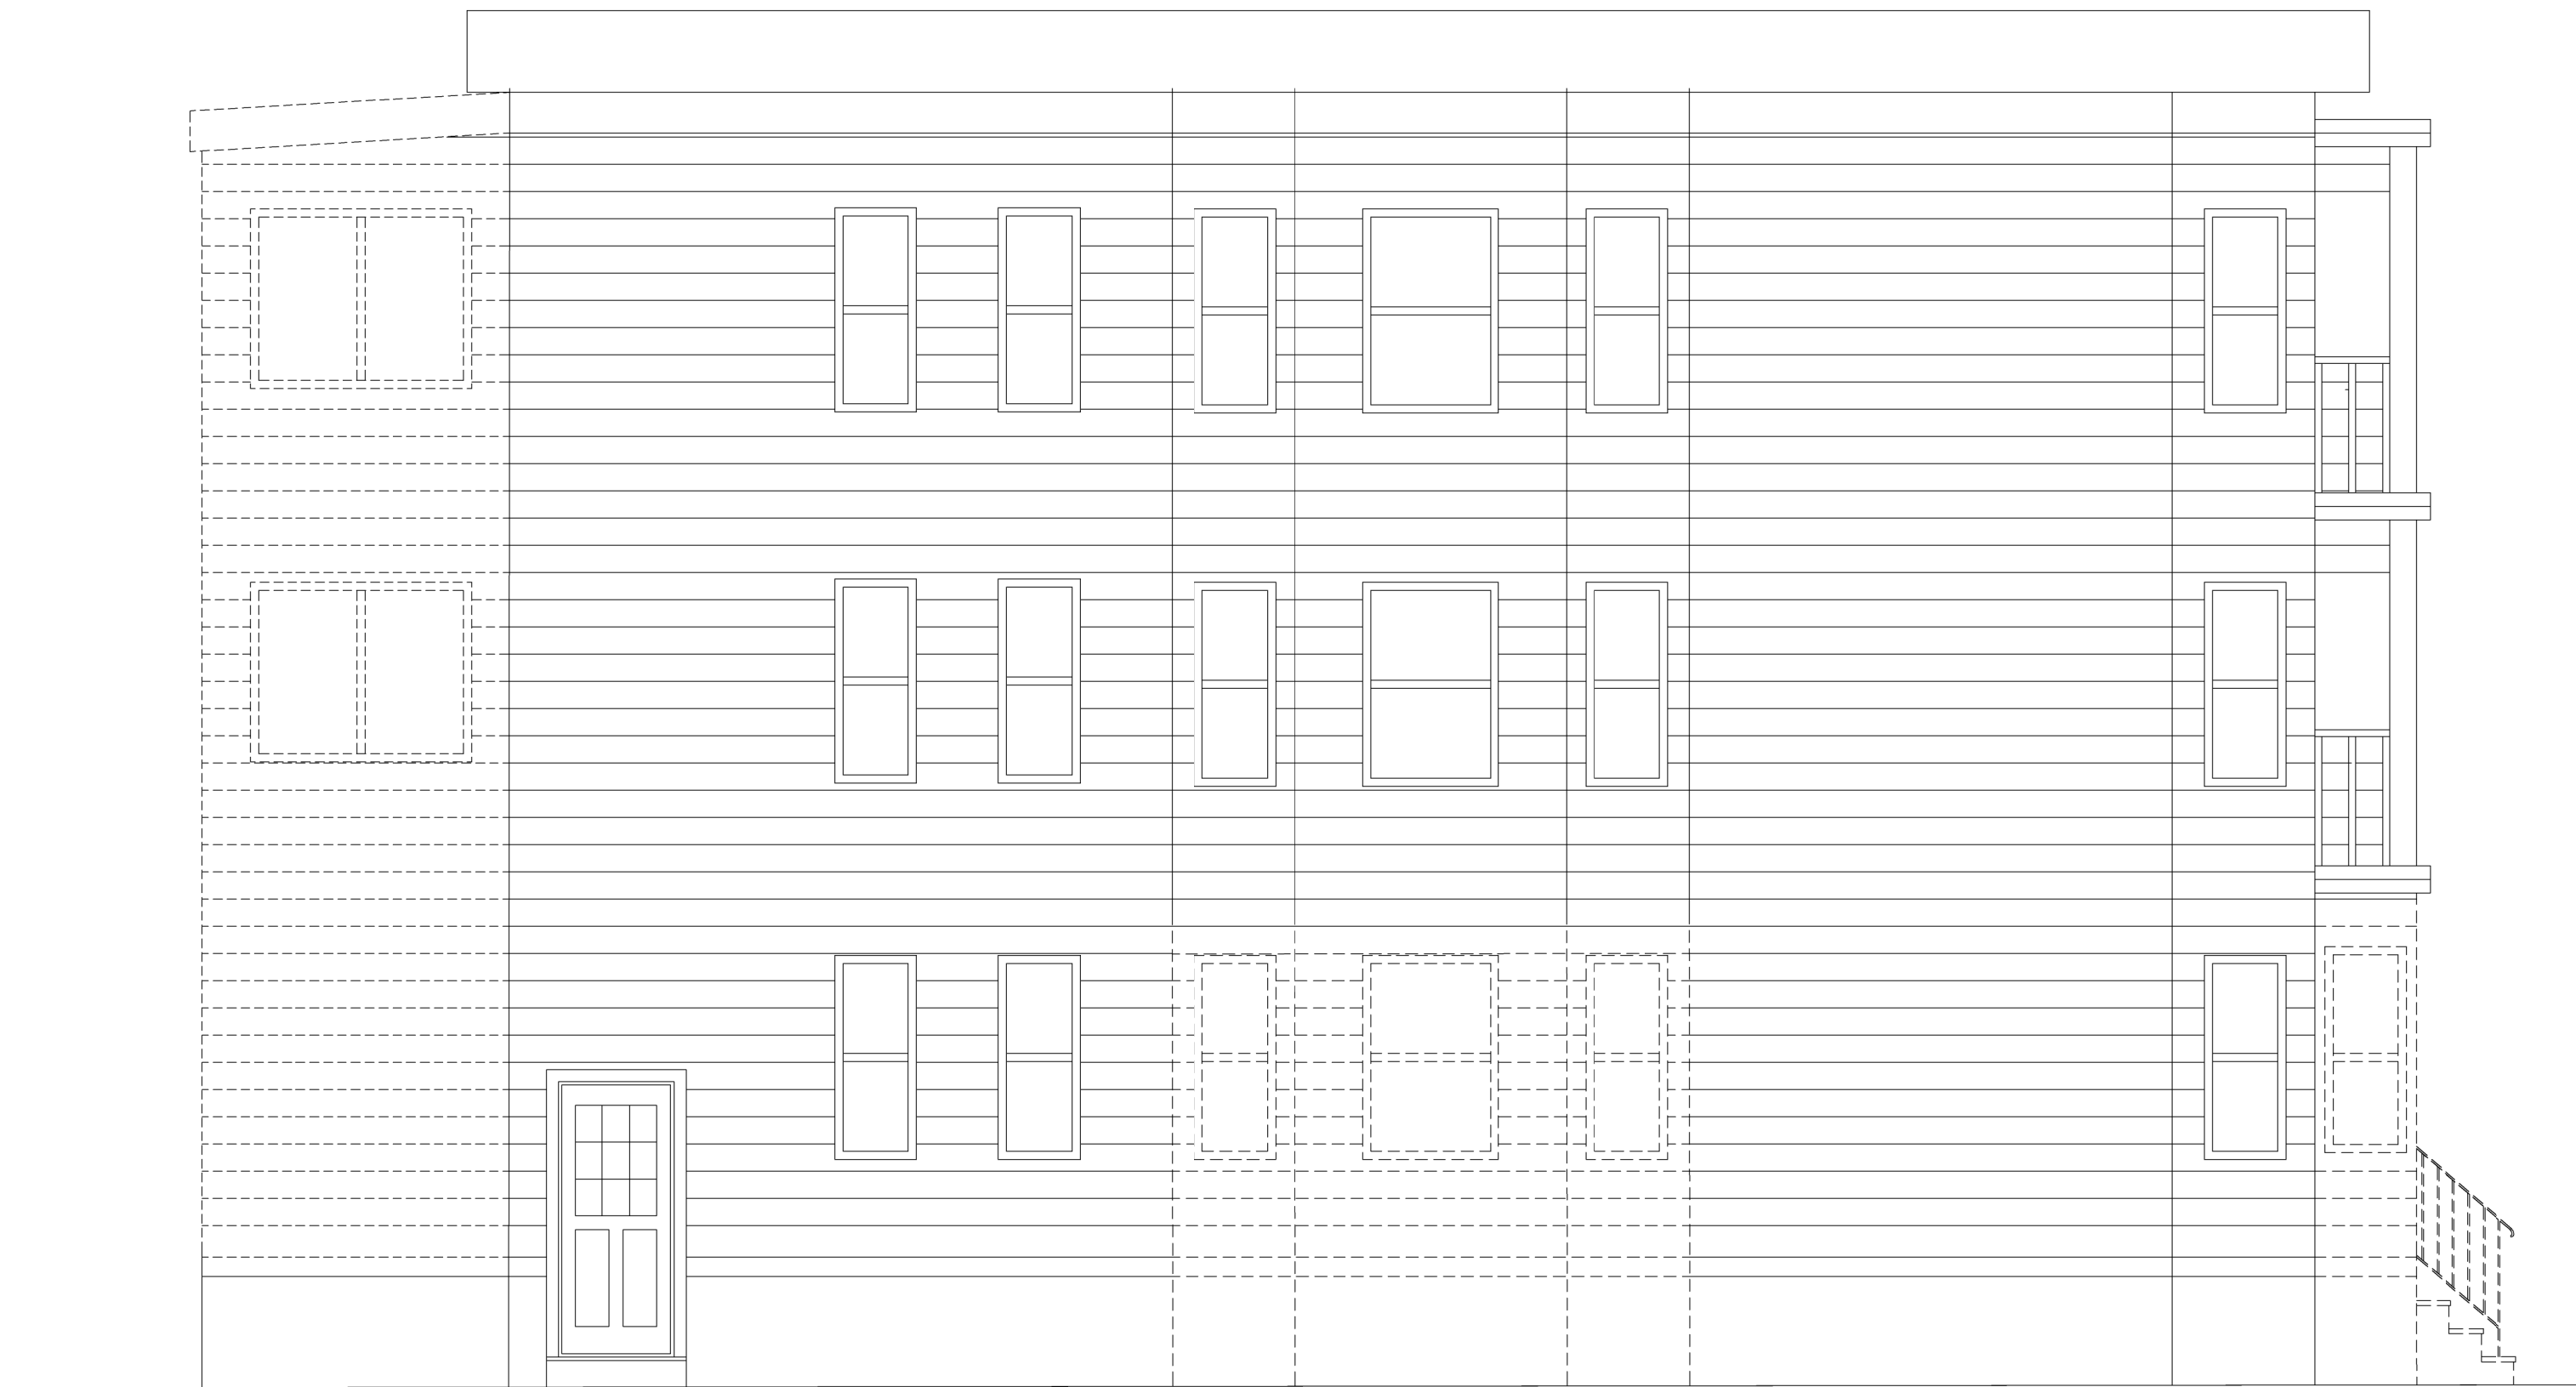

EXISTING RIGHT ELEVATION

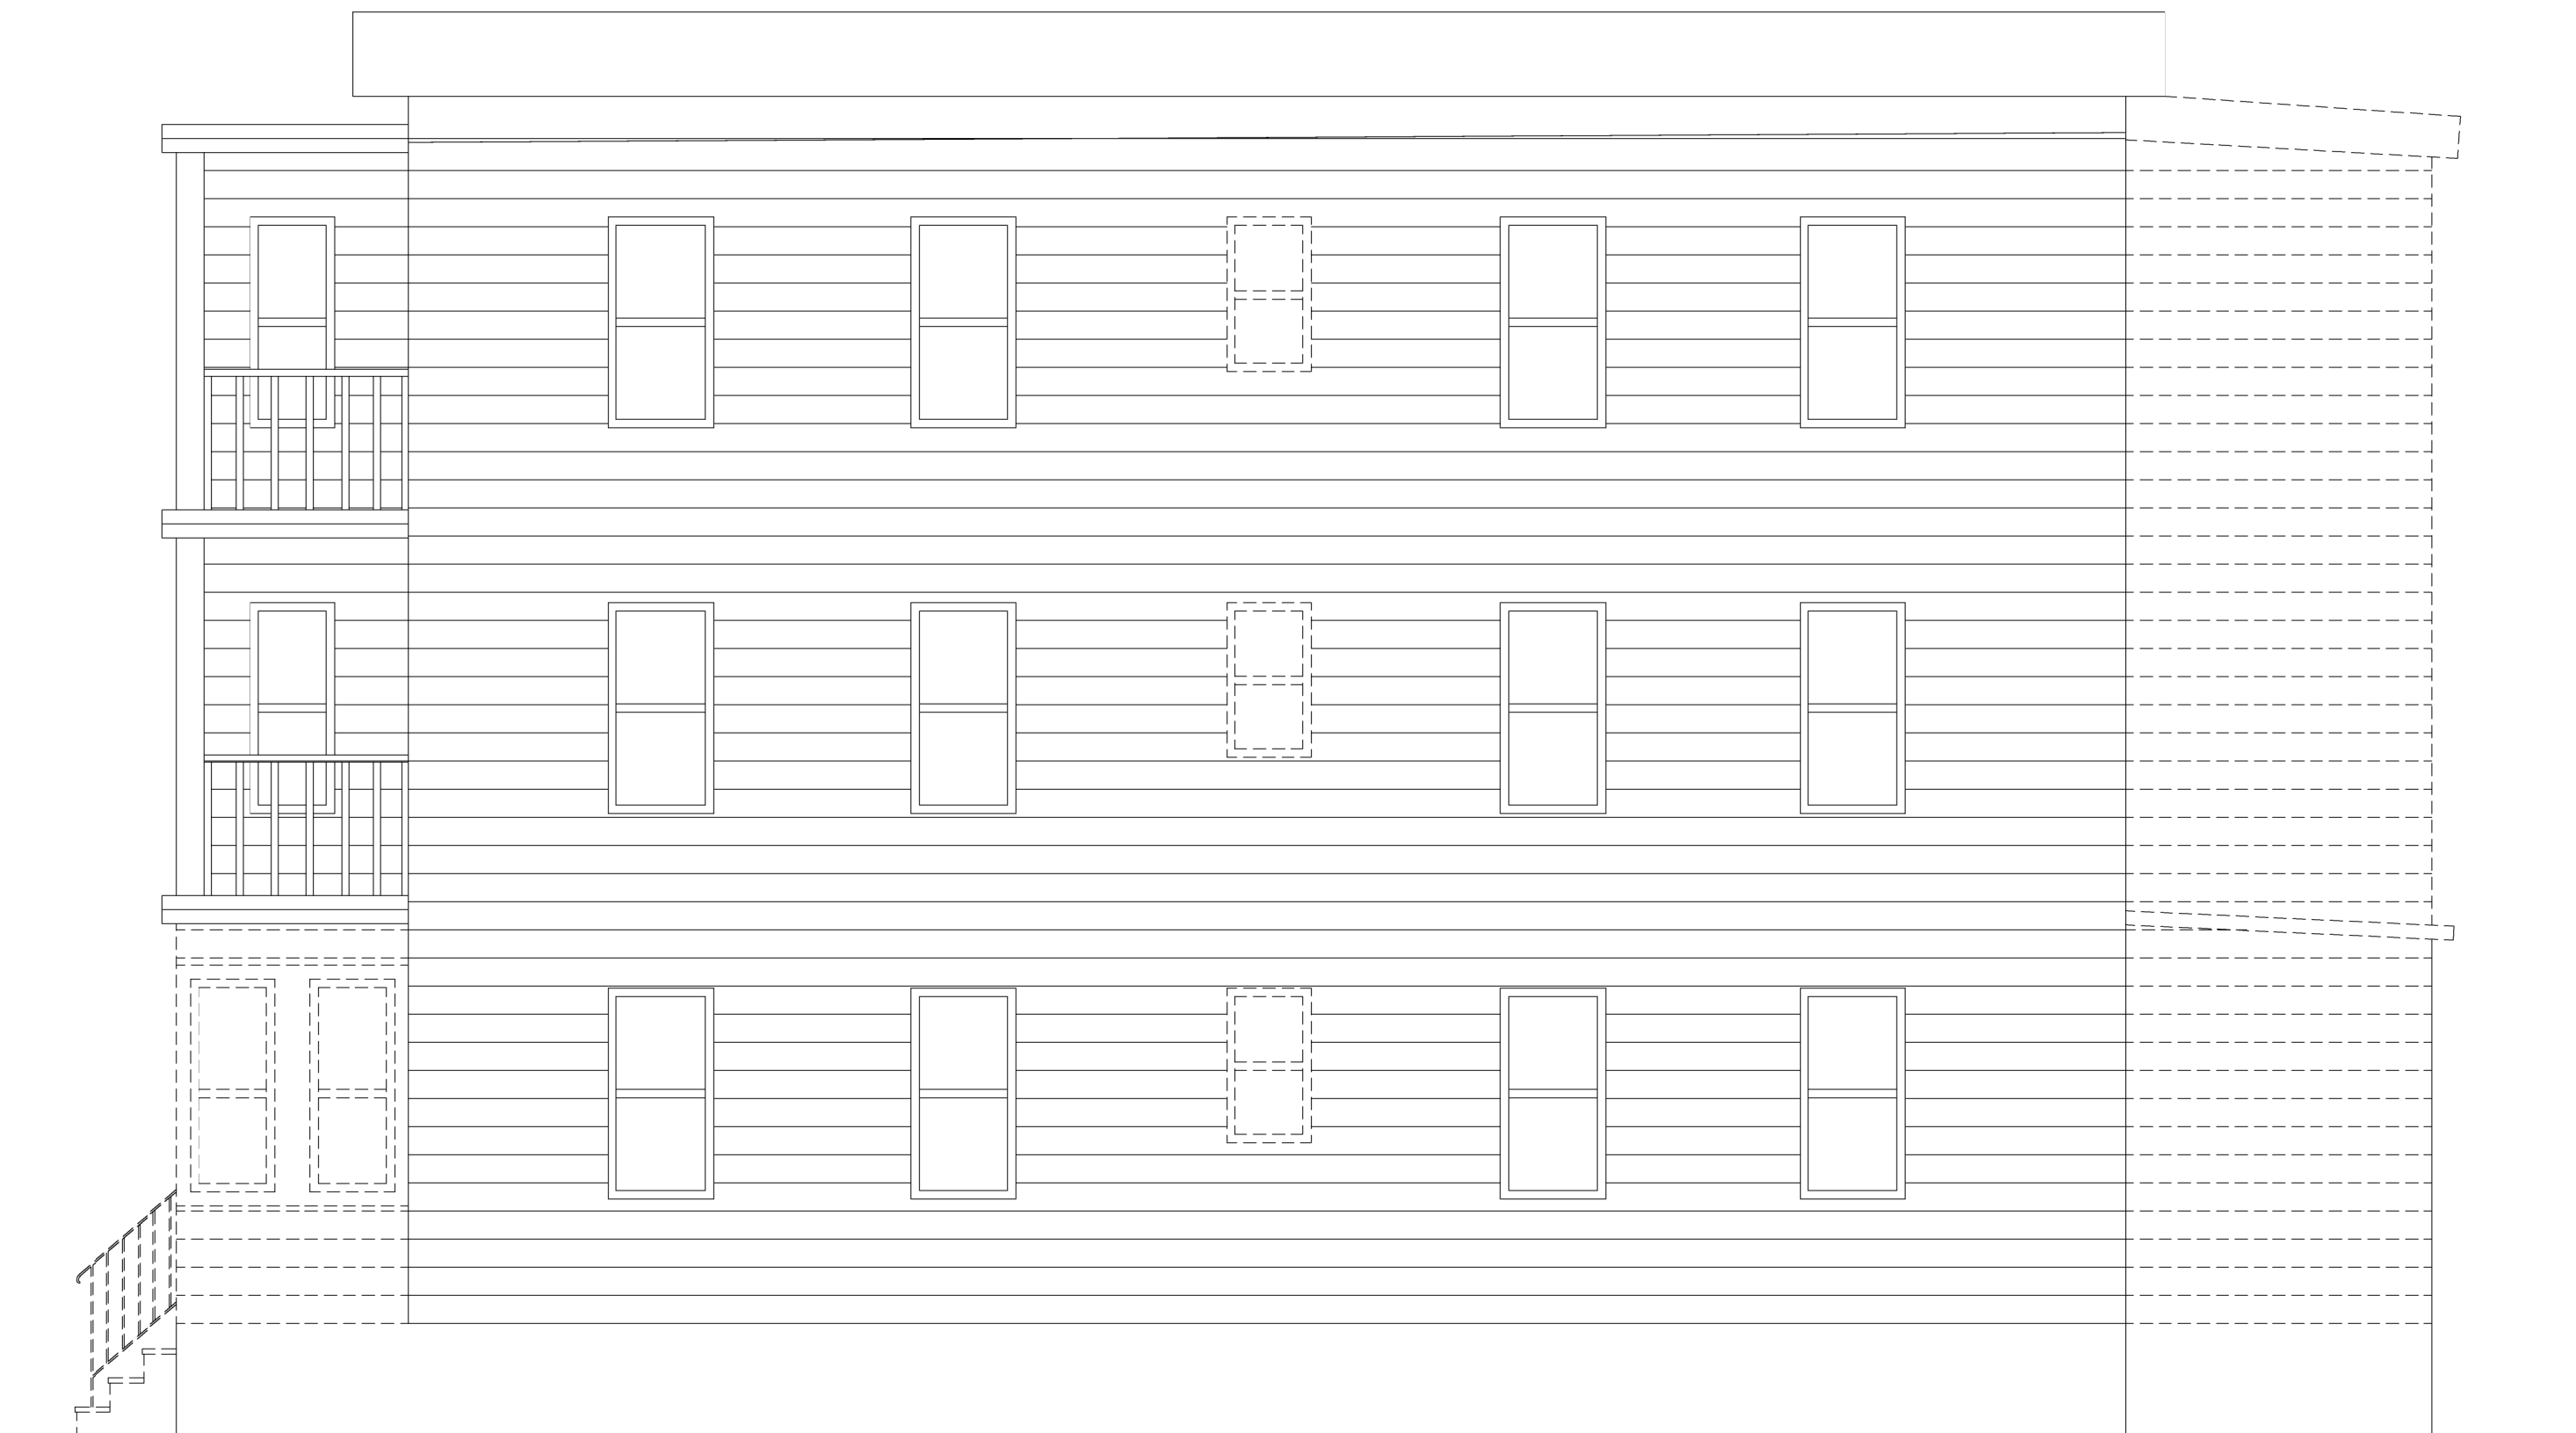

PROPOSED FRONT ELEVATION



EXISTING REAR ELEVATION


GENERAL NOTES:

1. CONTRACTOR TO VERIFY ALL DIMENSIONS PRIOR TO COMMENCING ANY NEW CONSTRUCTION.
2. CONTRACTOR SHALL VERIFY FLOOR TO FLOOR HEIGHTS PRIOR TO COMMENCING CONSTRUCTION.
3. CONTRACTOR SHALL REPORT ANY DISCREPANCIES TO THE ARCHITECT FOR INSTRUCTION.
4. ALL WORK TO BE EXECUTED IN ACCORDANCE WITH STATE AND LOCAL CODES AND INDUSTRY STANDARD CONSTRUCTION REQUIREMENTS.
5. INSULATION REQUIREMENTS WERE PREPARED IN ACCORDANCE WITH STATE BUILDING CODE. MANY COMMUNITIES HAVE INCREASED THESE REQUIREMENTS BY ADOPTING "ENERGY STRETCH CODE". CHECK WITH LOCAL BUILDING DEPARTMENT REGARDING THESE REQUIREMENTS, EXCEPTIONS, AND WAIVERS.

ARCHITECT'S NOTES:

1. THESE DRAWINGS WERE PREPARED FOR BUILDING PERMIT PURPOSES.
2. OTHER BUILDING SYSTEMS SUCH AS: MECHANICAL, ELECTRICAL, PLUMBING, EXTERIOR FINISHES, HANDRAIL, WINDOW & ROOFING SHALL BE SELECTED BY THE OWNER.
3. ALL OWNER SELECTED SYSTEMS SHALL BE INSTALLED PER MANUFACTURER'S SPECIFICATIONS & COORDINATED WITH THESE DRAWINGS.

TITLE: EXISTING ELEVATIONS		COMMISSION NO. C041019		Sheet A3	
ADDITION & INTERIOR RENOVATION		96 WHEATLAND ST. SOMERVILLE, MA			
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SCALE: 1/4" = 1'-0" OR AS NOTED		BY			
DRAWN BY: M.R.L.		CHK'D BY: R.H.T.		DATE: 5-30-19	

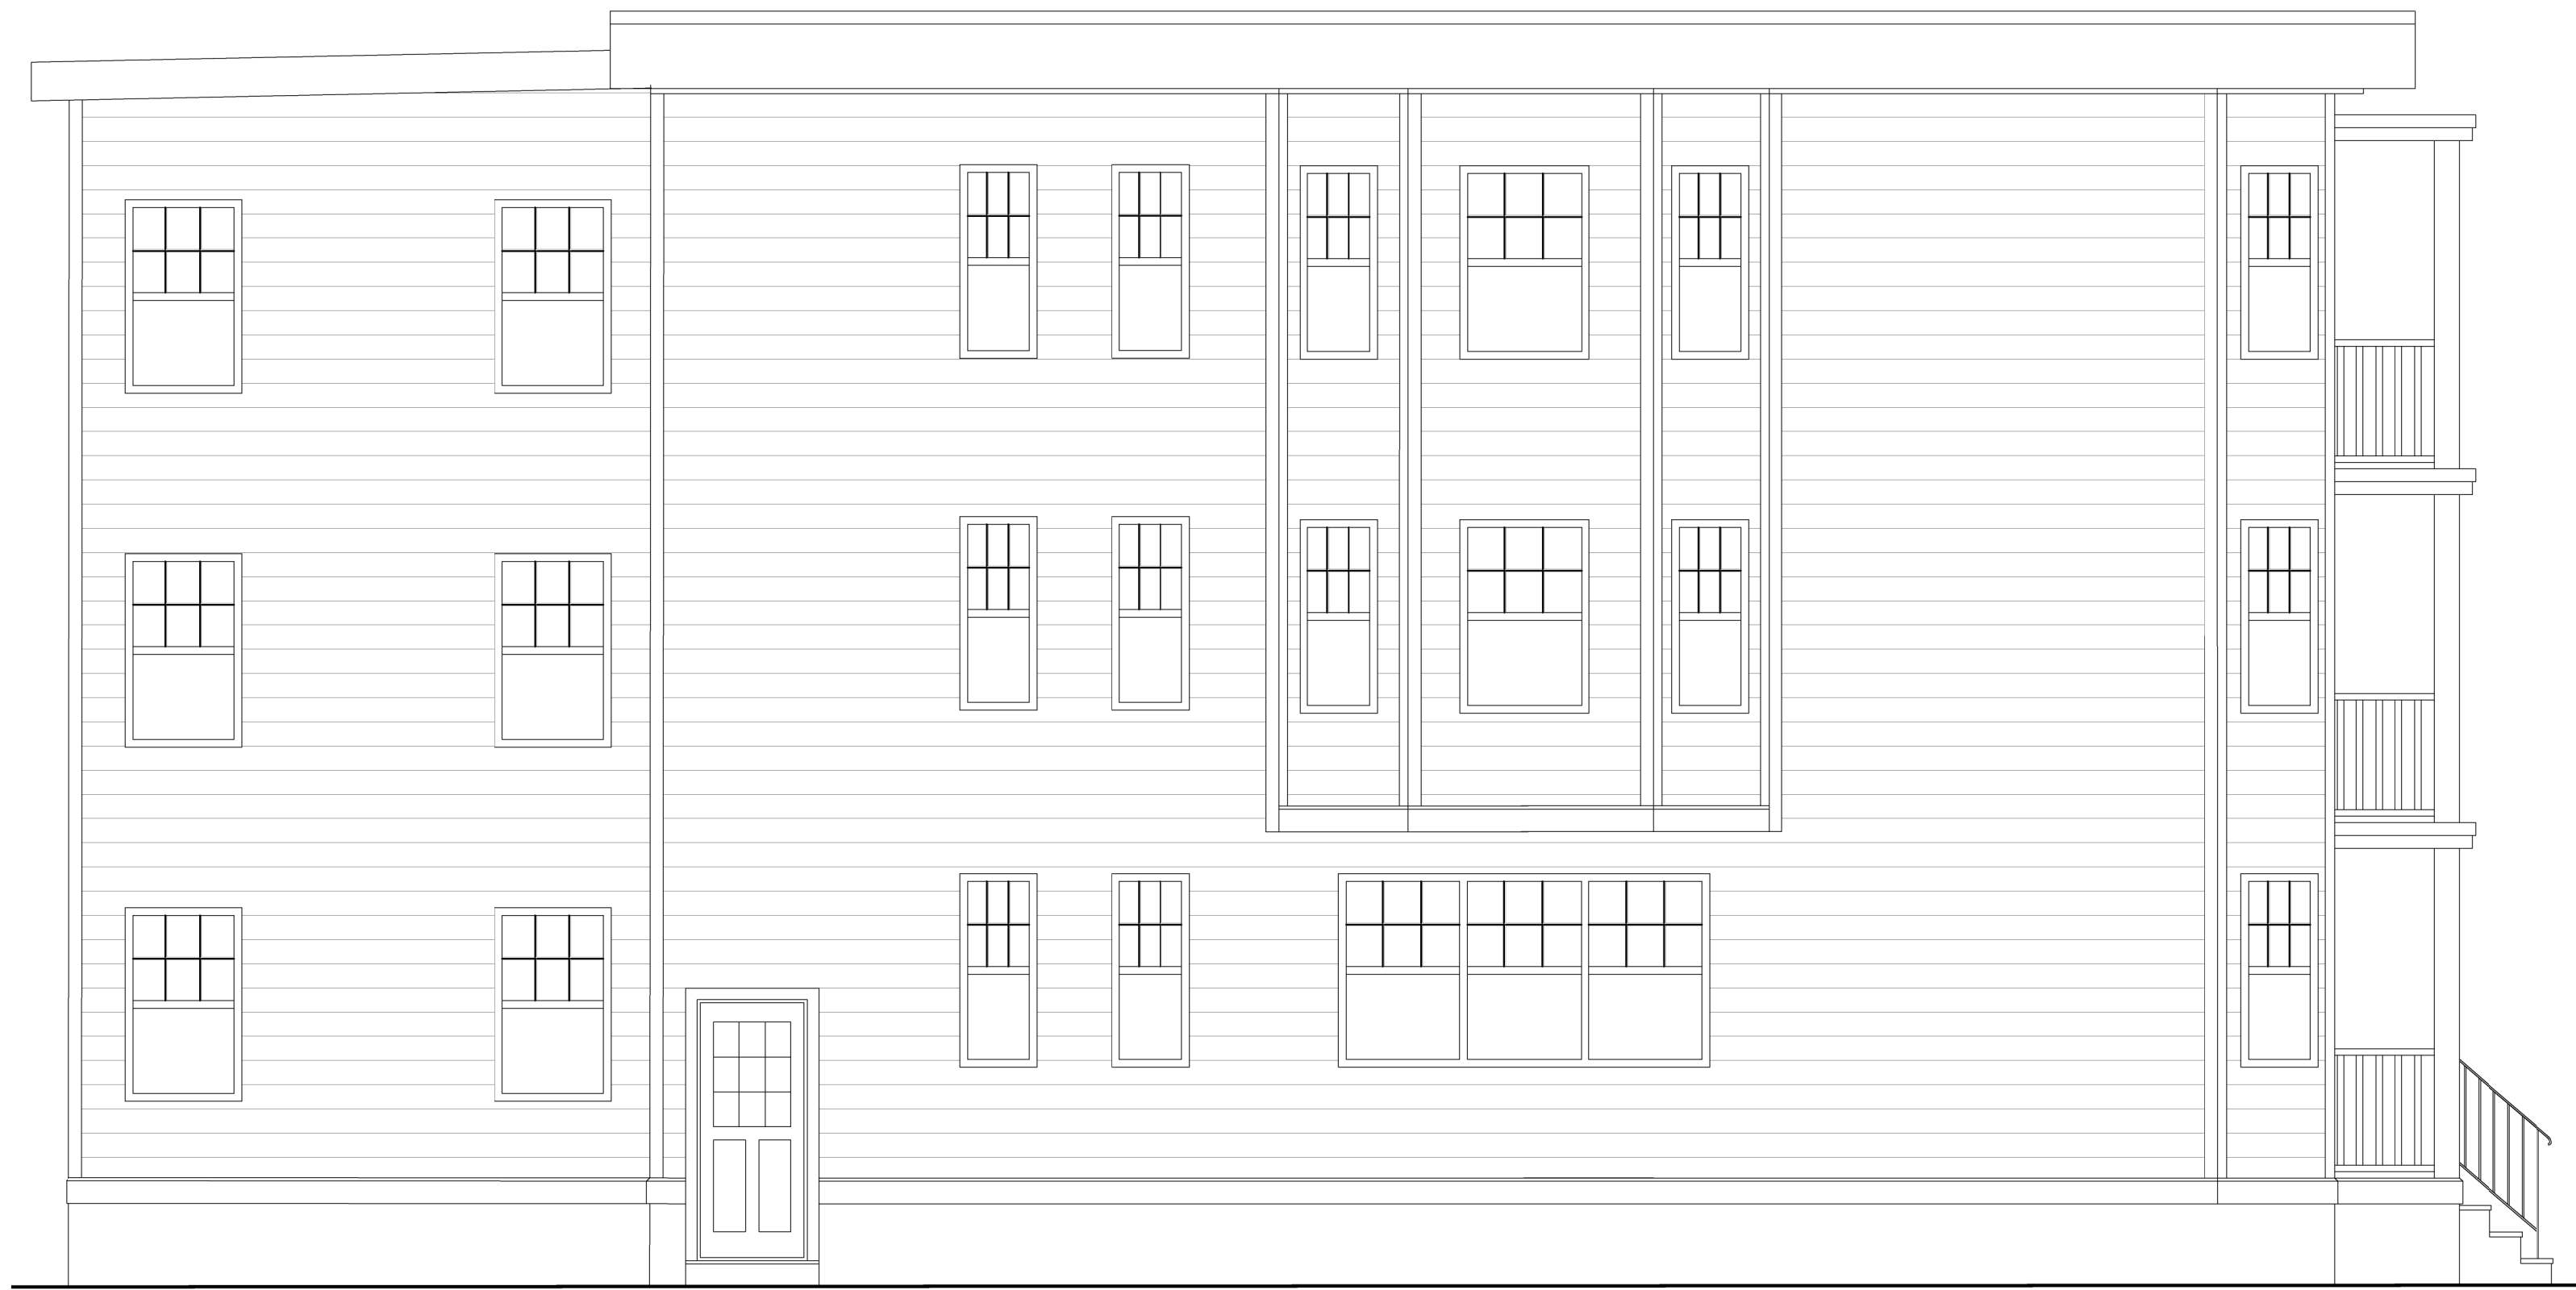


PROPOSED LEFT ELEVATION



PROPOSED RIGHT ELEVATION



PROPOSED FRONT ELEVATION

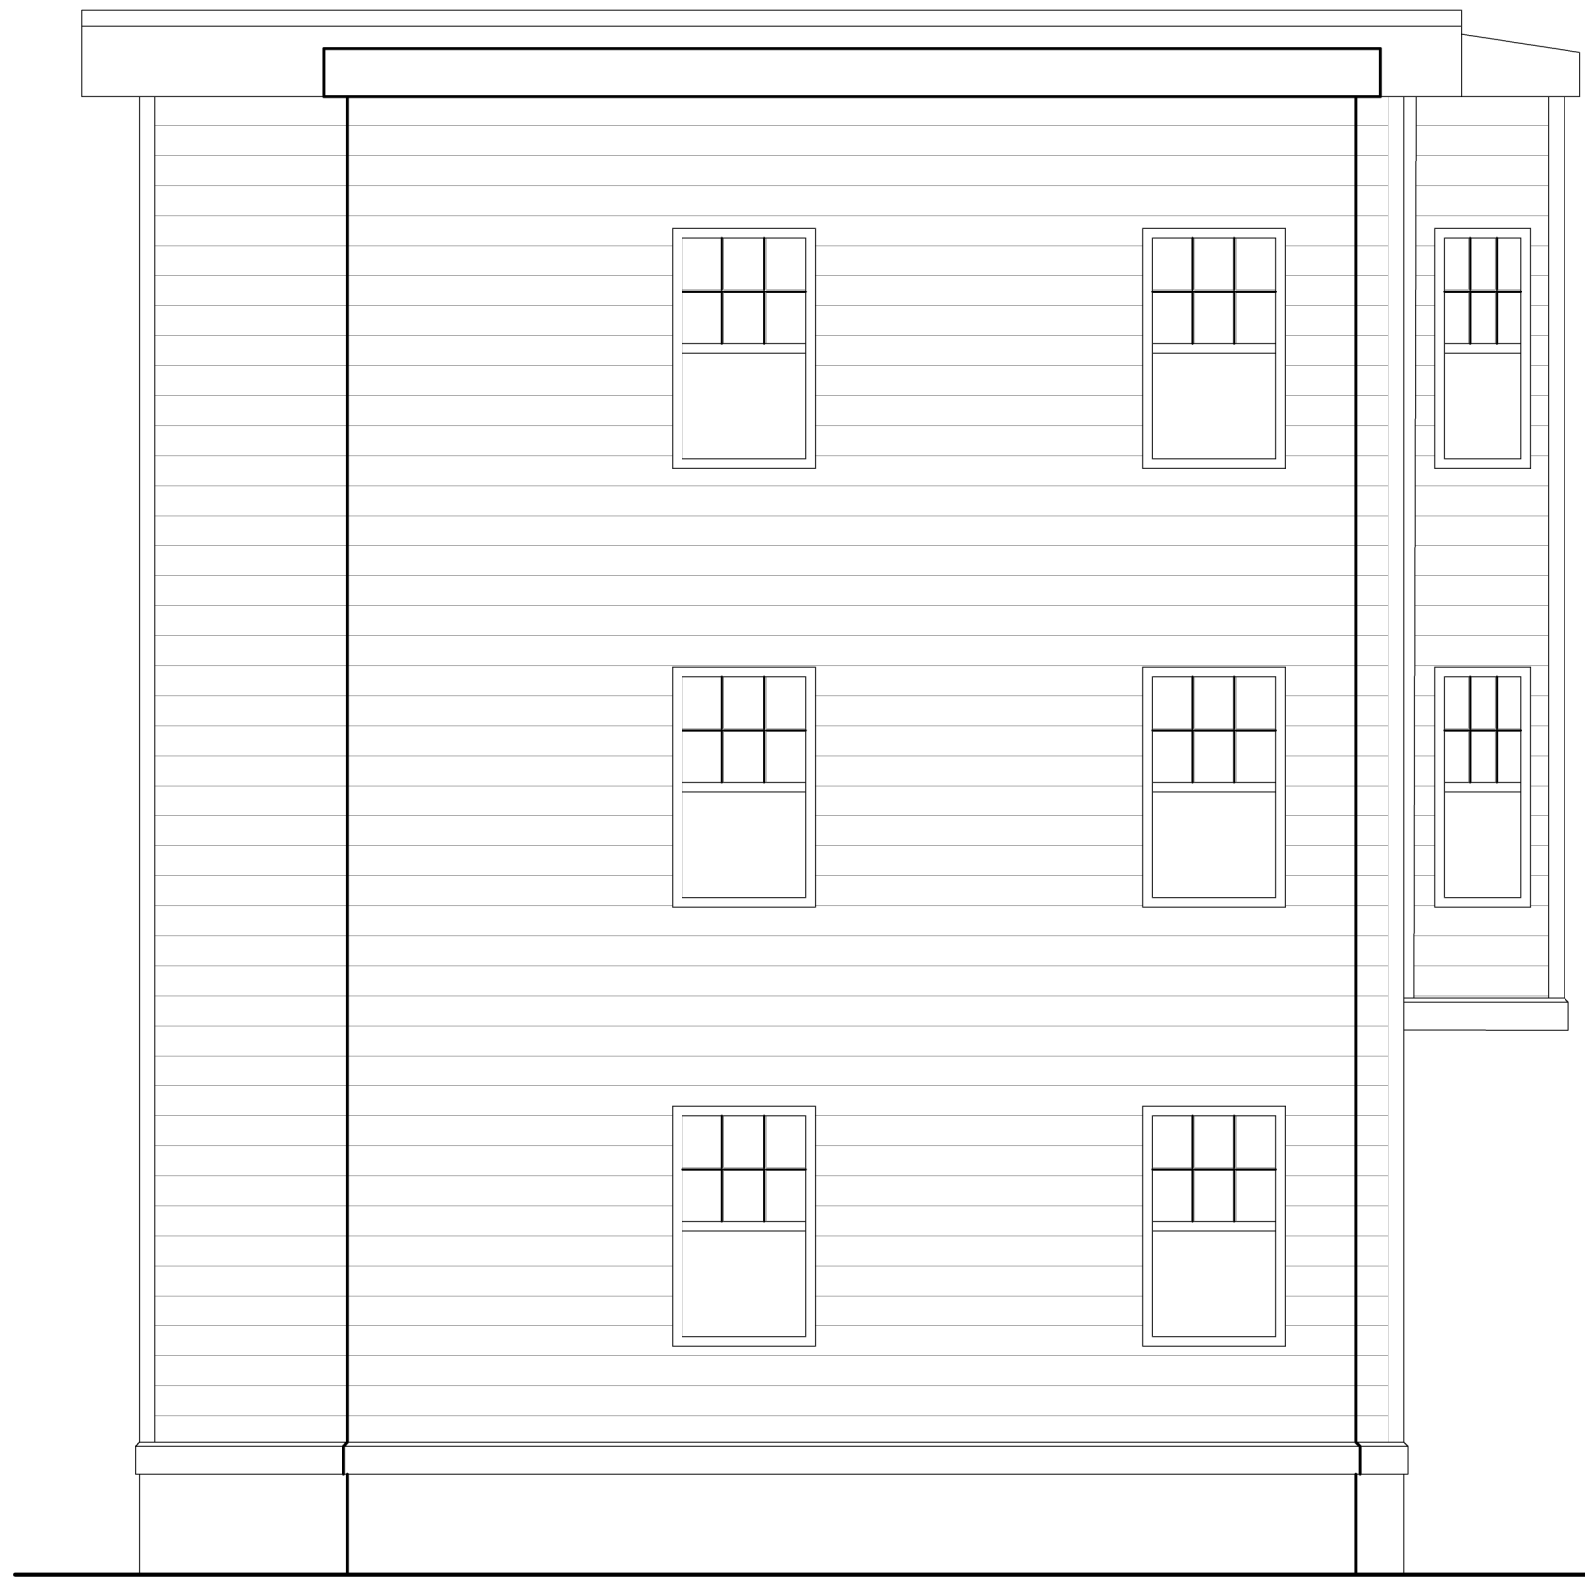

PROPOSED REAR ELEVATION

GENERAL NOTES:
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4. ALL WORK TO BE EXECUTED IN ACCORDANCE WITH STATE AND LOCAL CODES AND INDUSTRY STANDARD CONSTRUCTION REQUIREMENTS.
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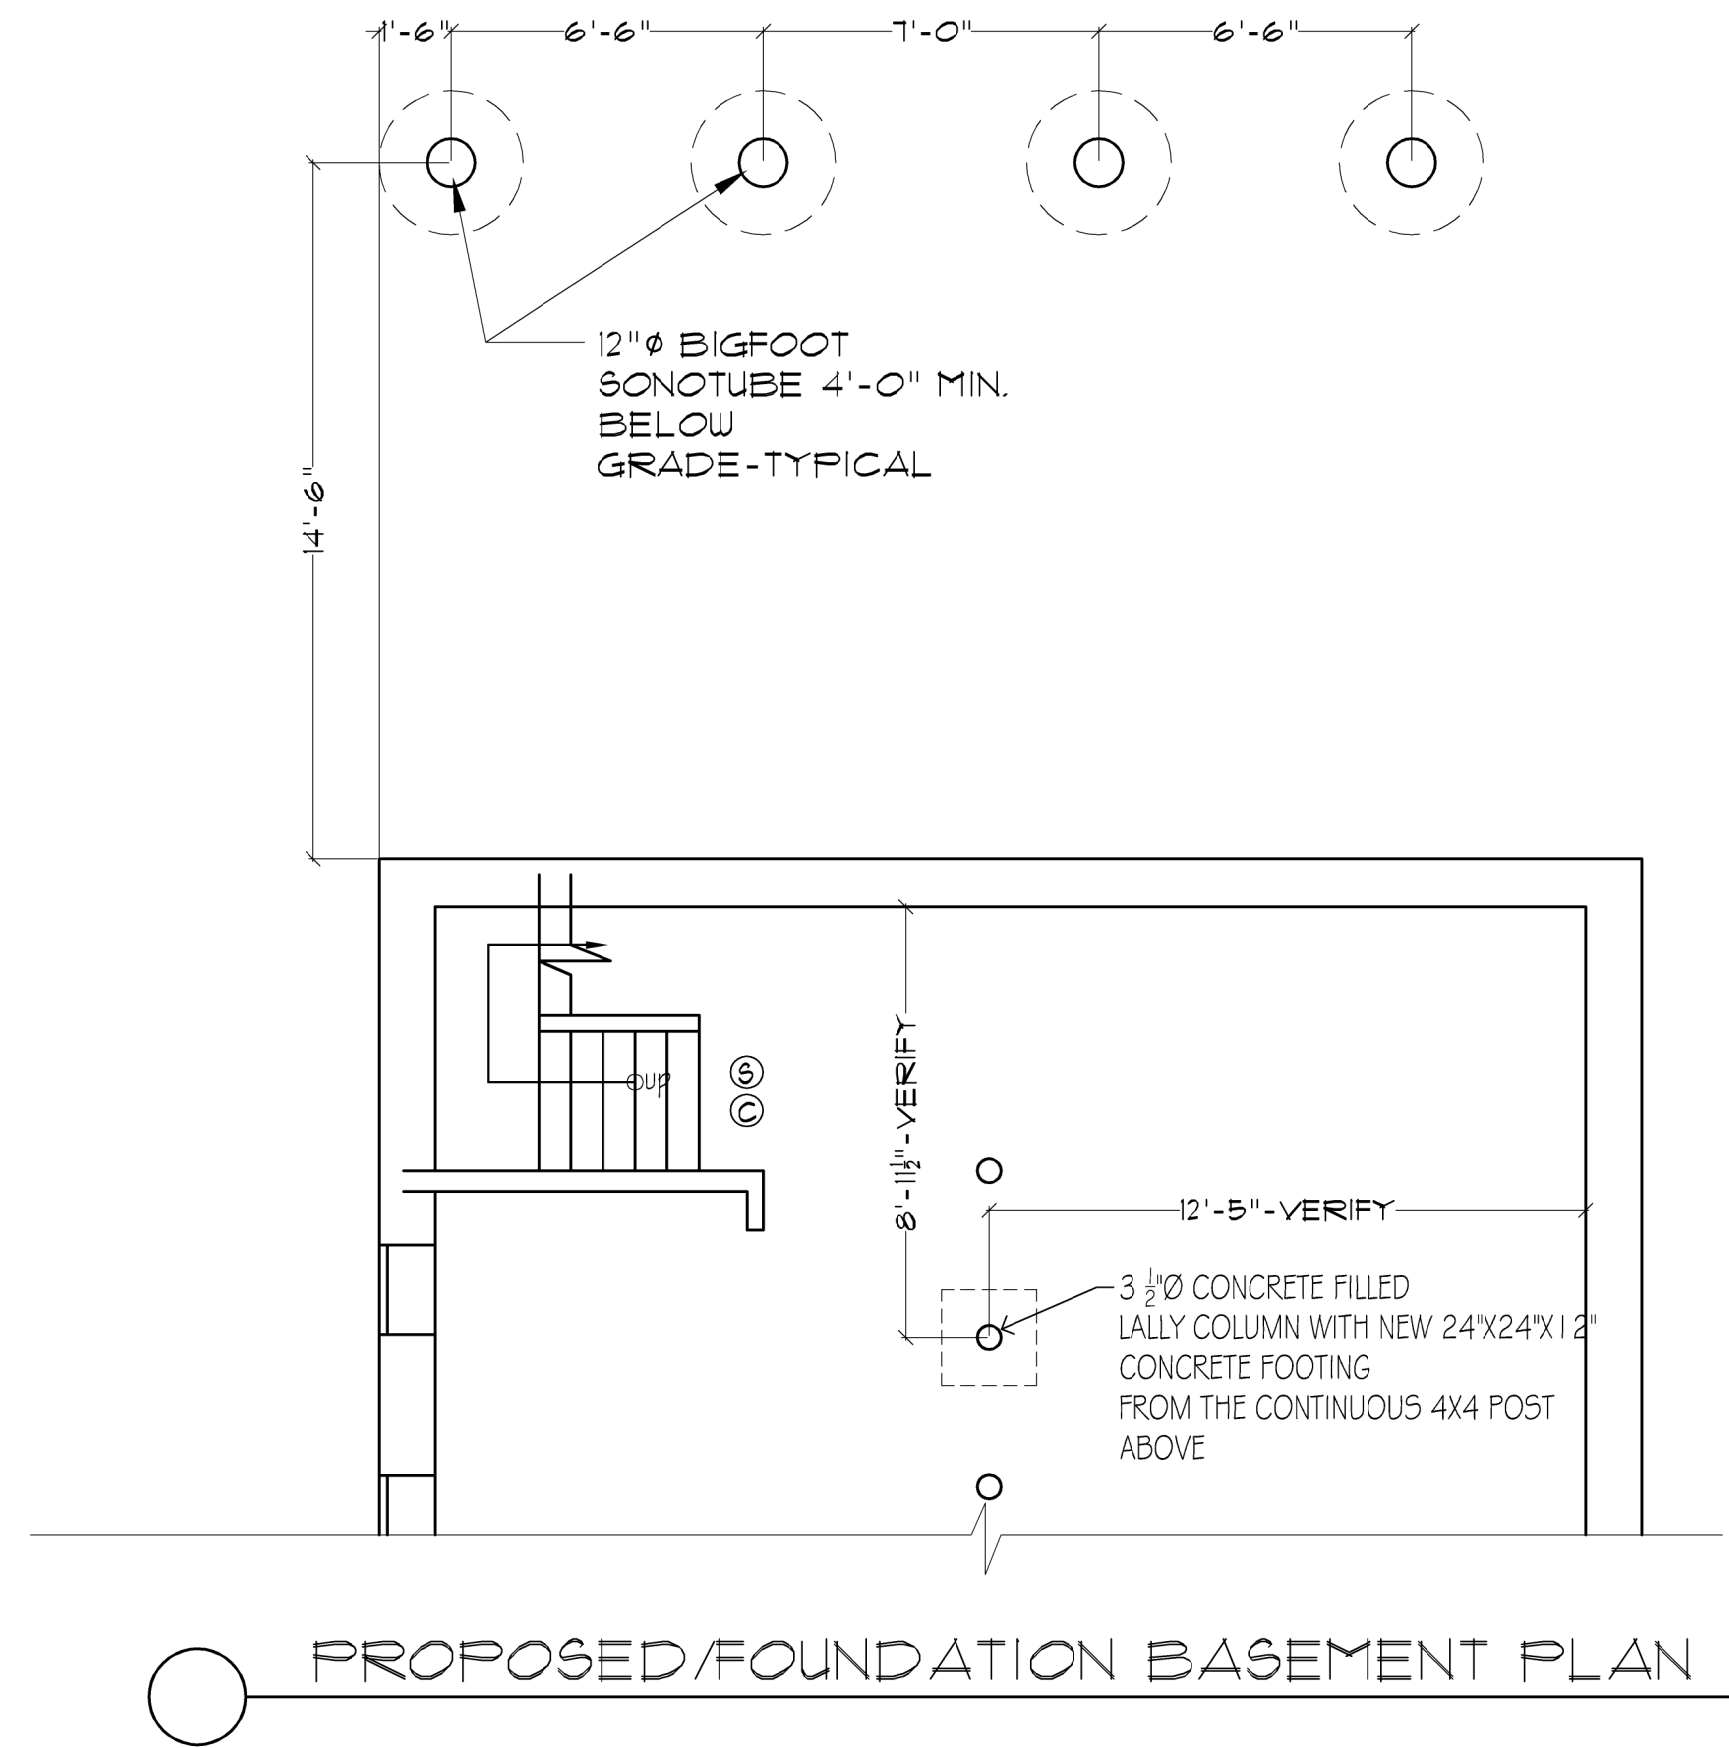
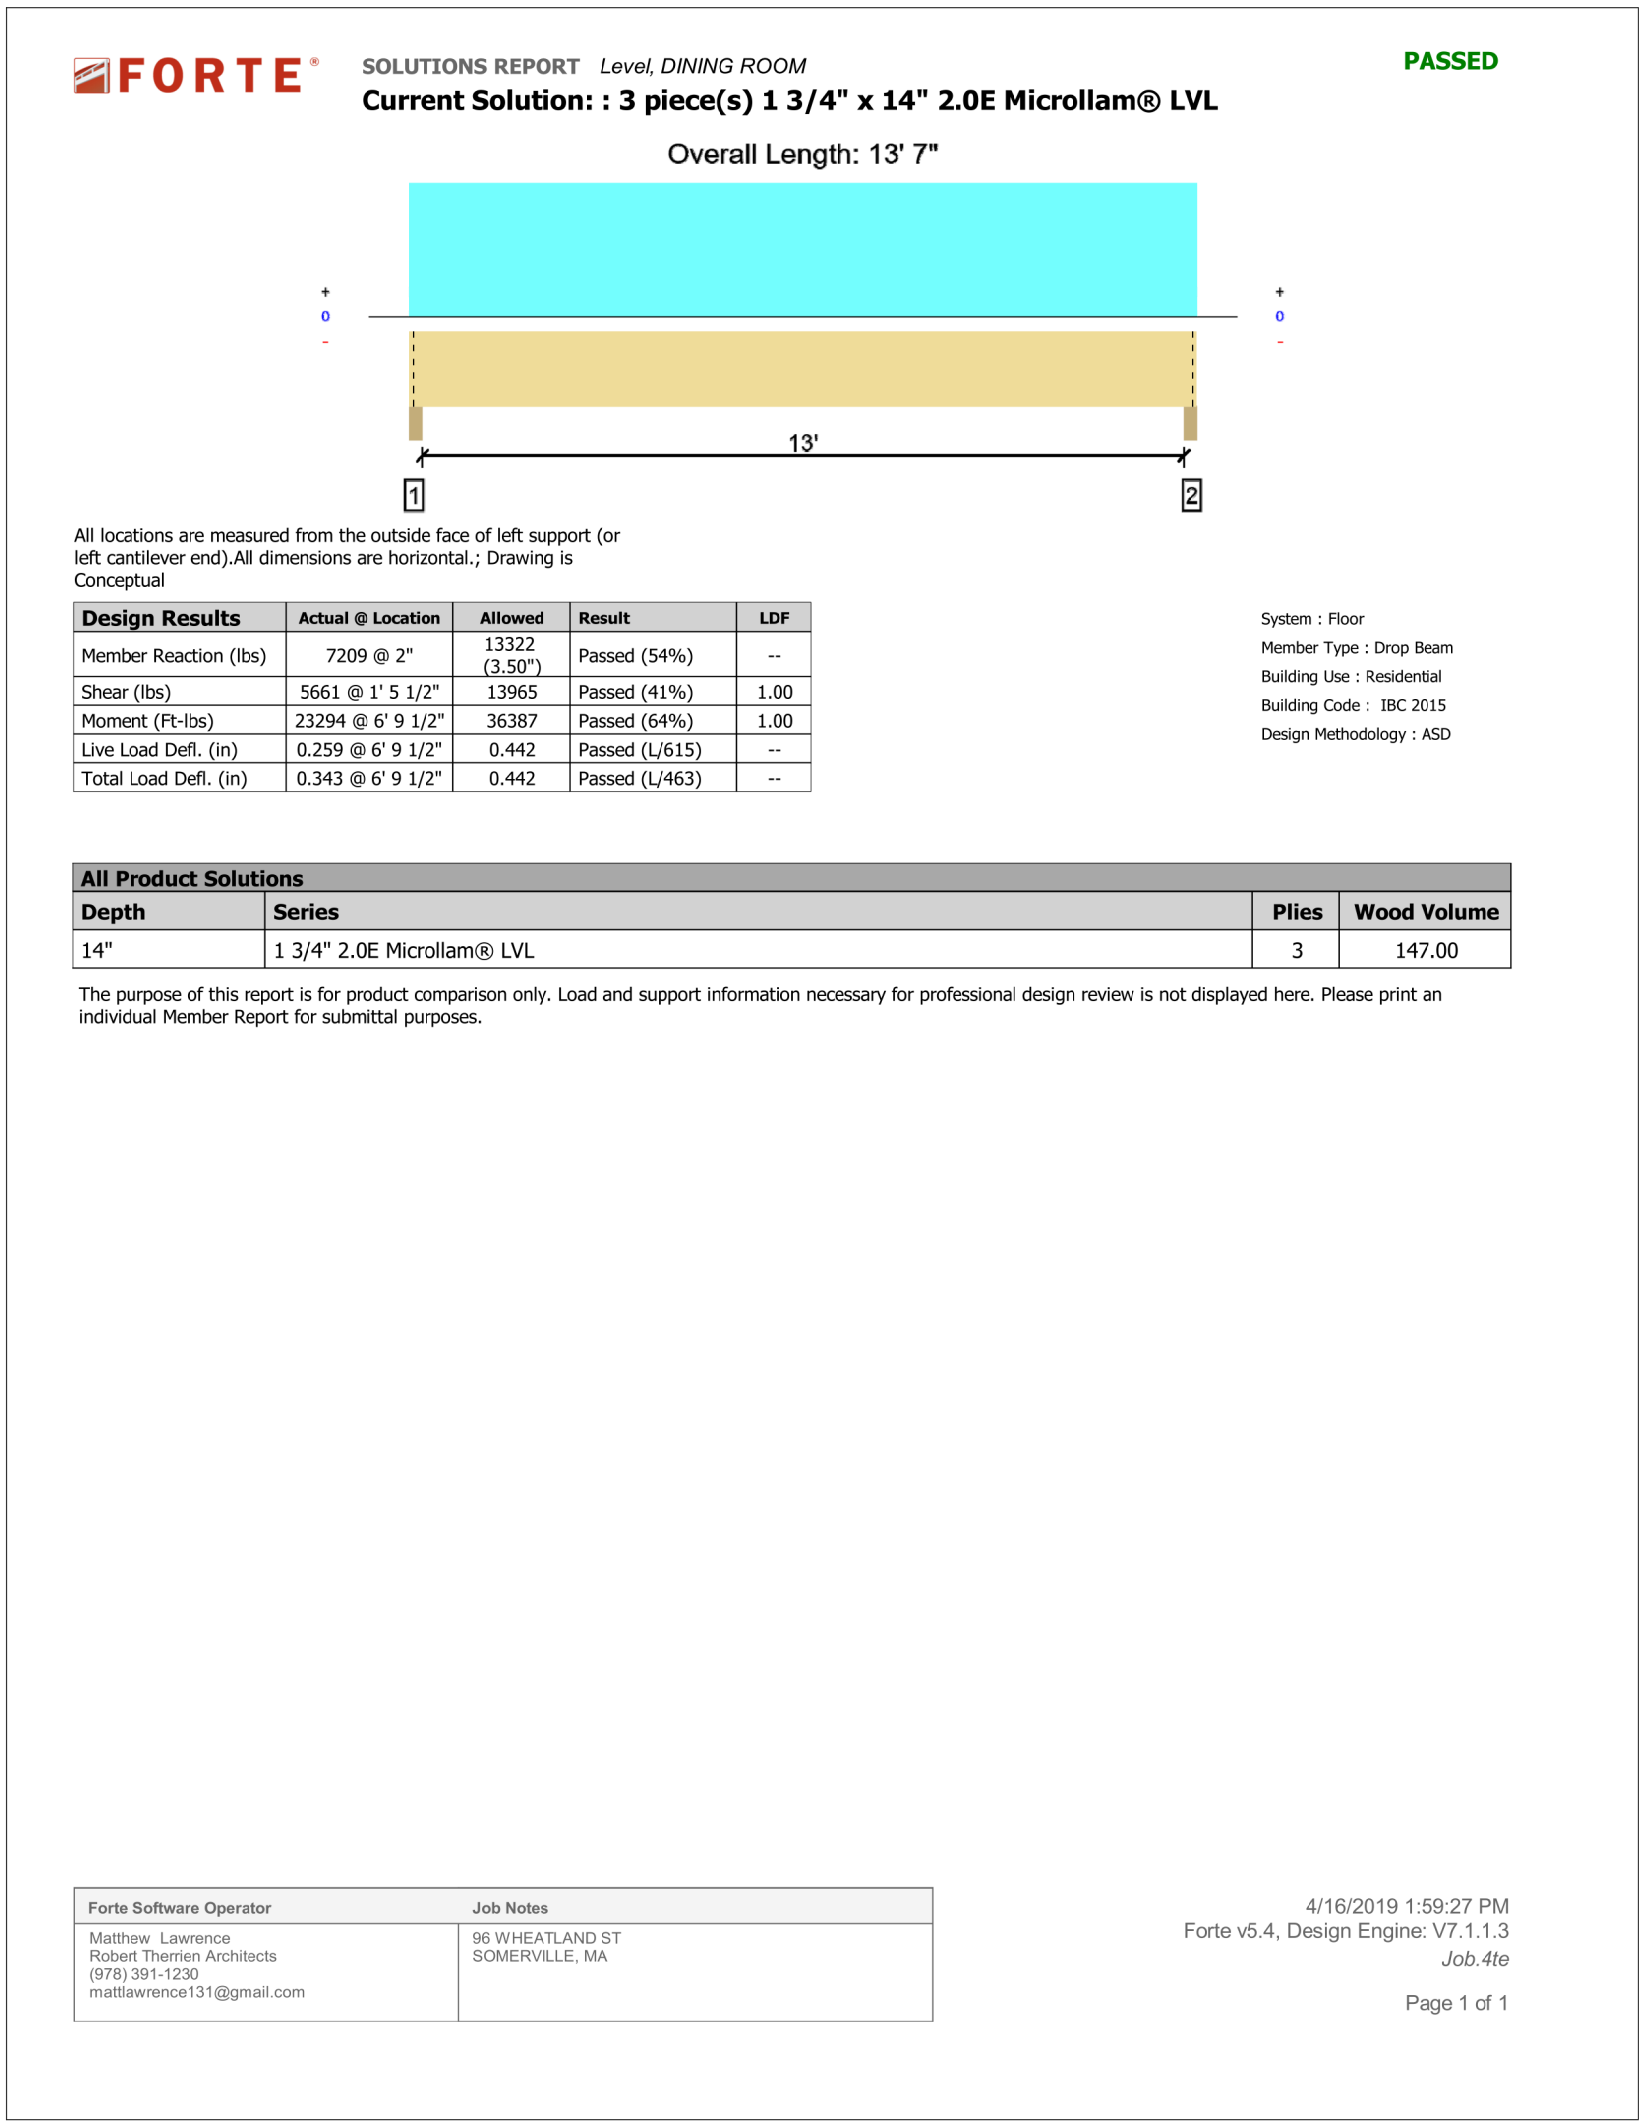
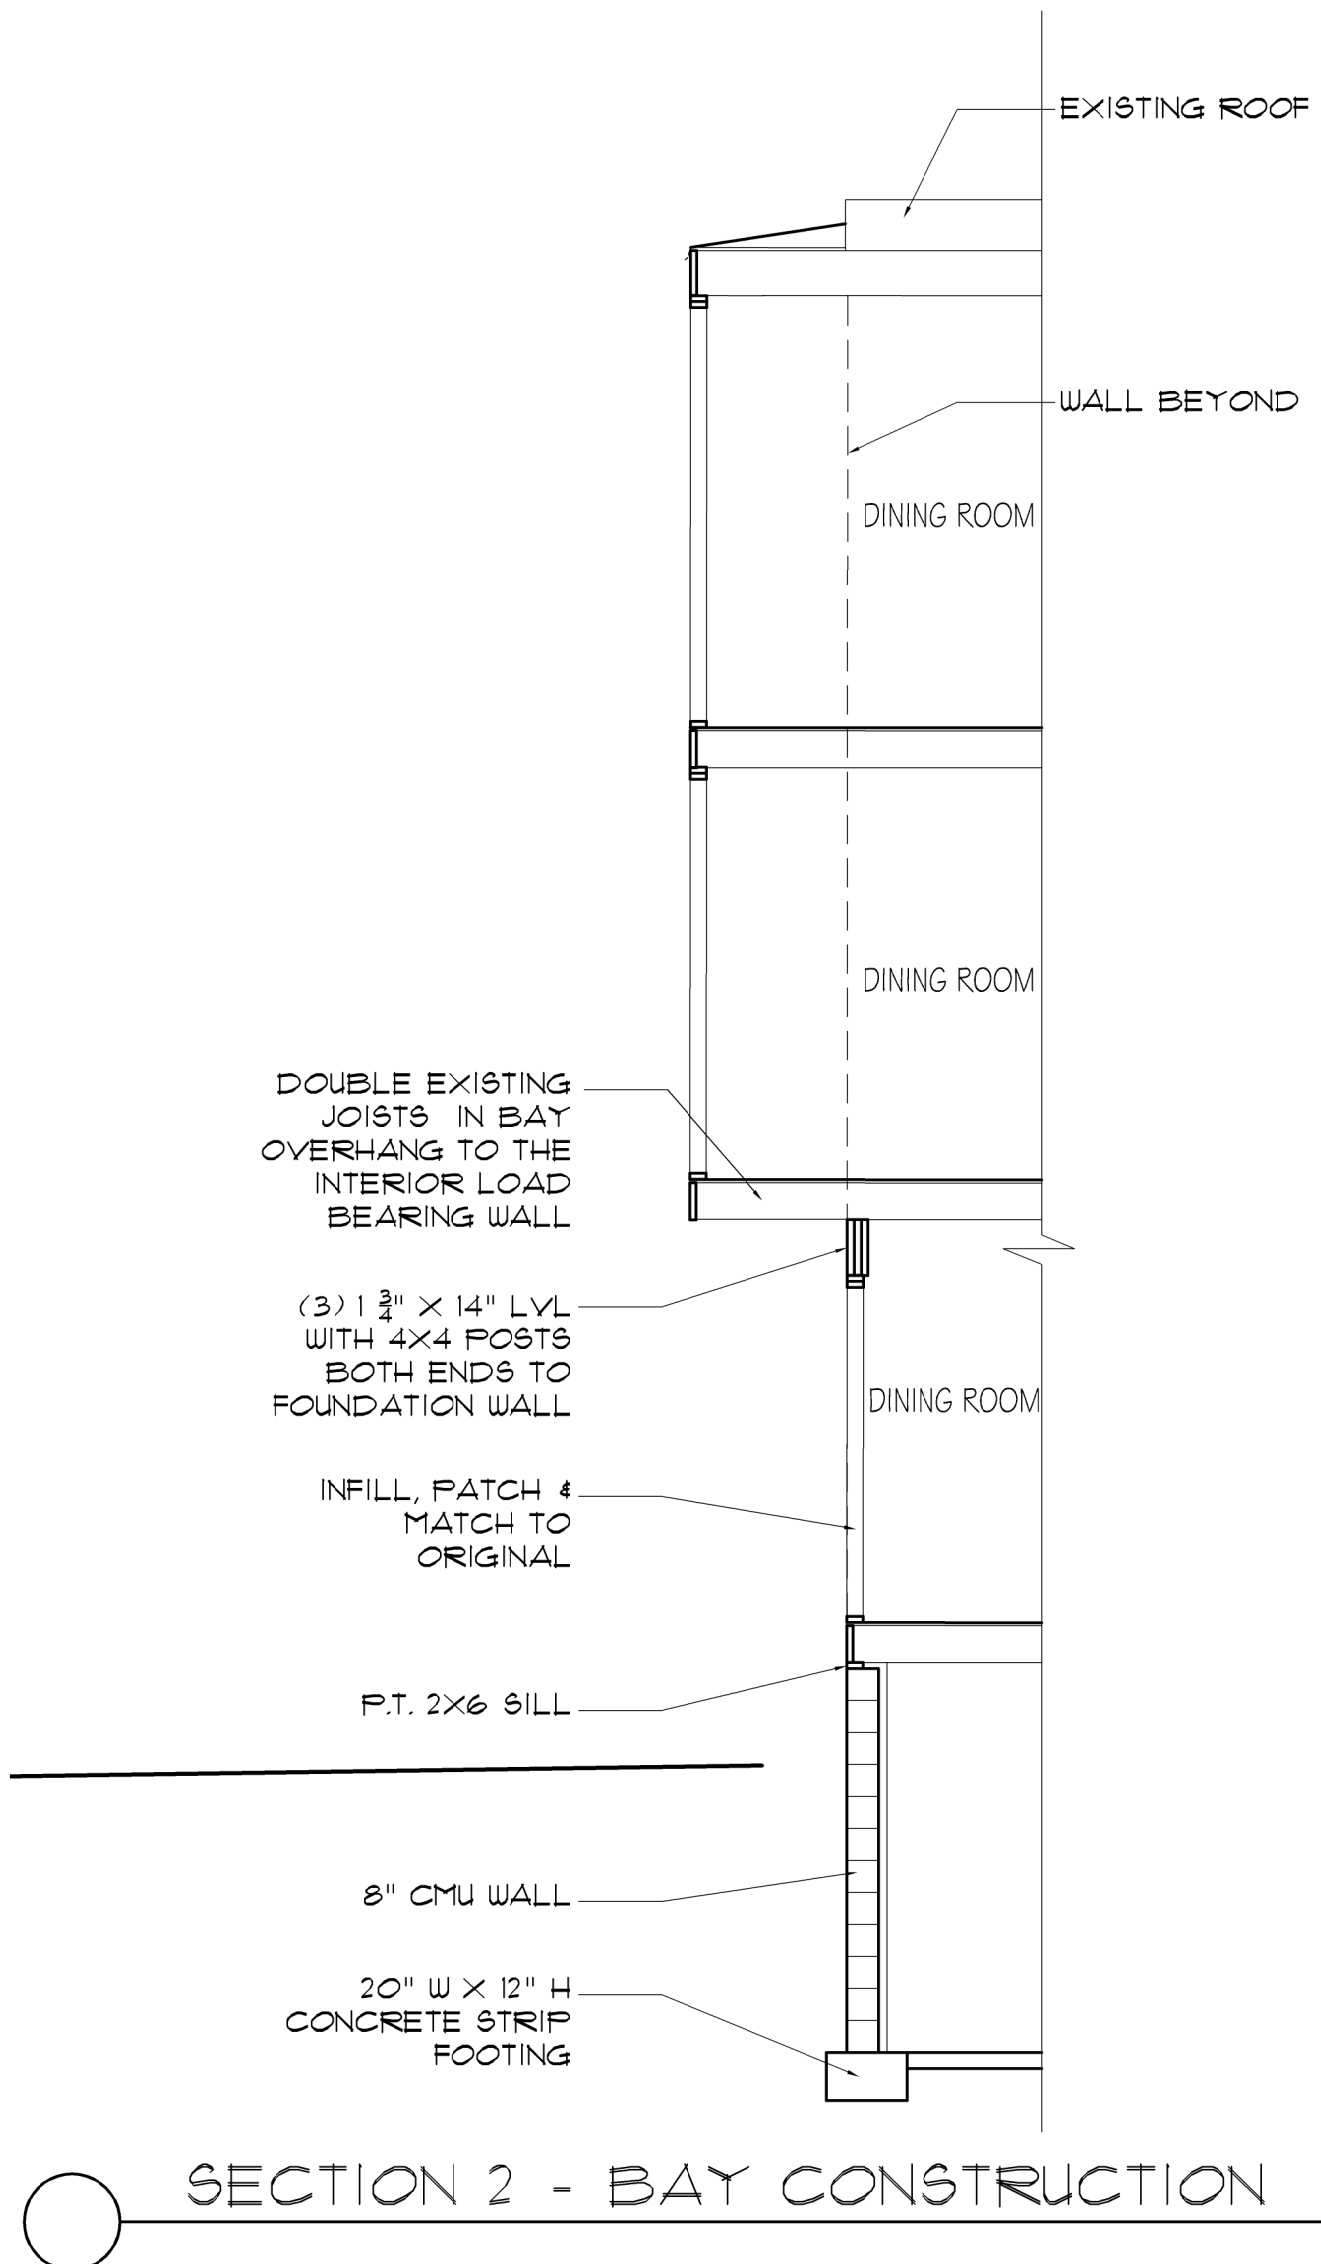
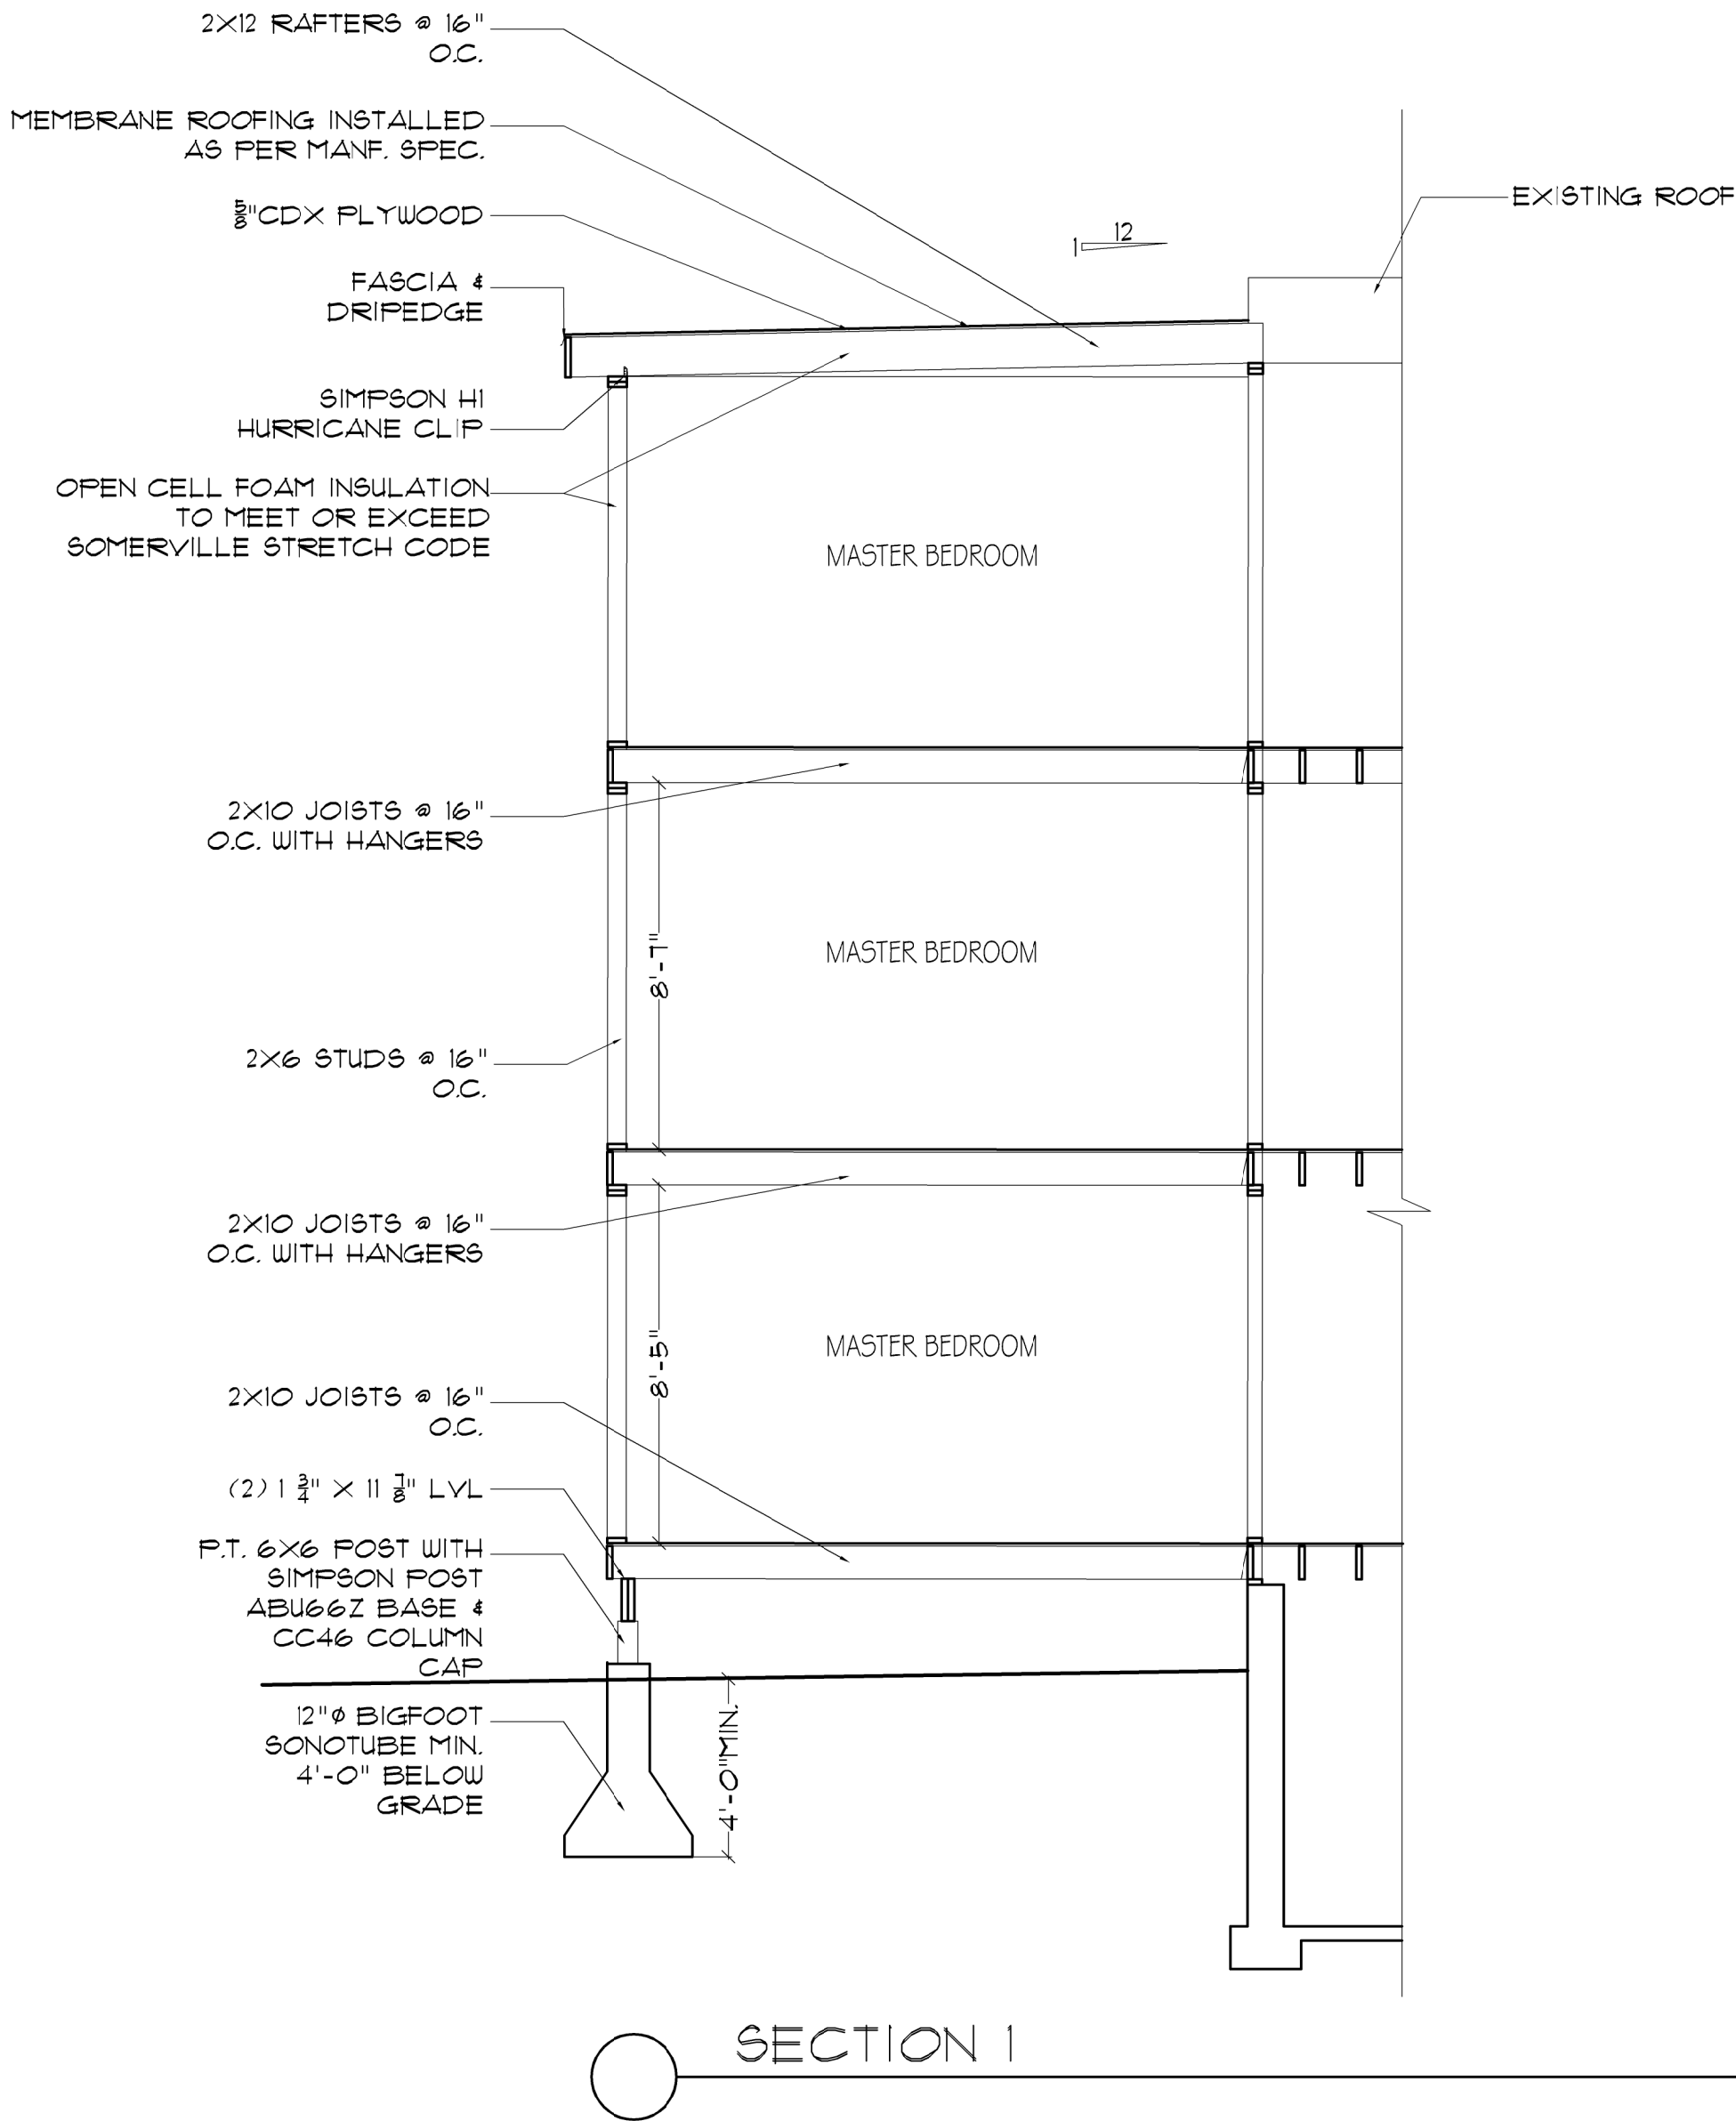
TITLE: PROPOSED ELEVATIONS		COMMISSION NO. C041019		Sheet A4	
ADDITION & INTERIOR RENOVATION		96 WHEATLAND ST. SOMERVILLE, MA		REVISIONS	
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		DATE: 5.30.19			

GENERAL NOTES:

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ARCHITECT'S NOTES:


1. THESE DRAWINGS WERE PREPARED FOR BUILDING PERMIT PURPOSES.
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3. ALL OWNER SELECTED SYSTEMS SHALL BE INSTALLED PER MANUFACTURER'S SPECIFICATIONS & COORDINATED WITH THESE DRAWINGS.



ROBERT THERRIEN, ARCHITECT

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TITLE: SECTION & FOUNDATION PLAN

ADDITION & INTERIOR RENOVATION

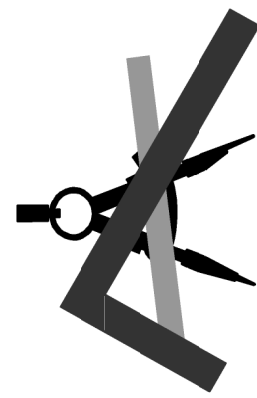96 WHEATLAND ST.
SOMERVILLE, MA

COMMISSION NO. C041019

Sheet


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GENERAL NOTES:


1. CONTRACTOR TO VERIFY ALL DIMENSIONS PRIOR TO COMMENCING ANY NEW CONSTRUCTION.
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ARCHITECT'S NOTES:


1. THESE DRAWINGS WERE PREPARED FOR BUILDING PERMIT PURPOSES.
2. OTHER BUILDING SYSTEMS SUCH AS: MECHANICAL, ELECTRICAL, PLUMBING, EXTERIOR FINISHES, HANDRAIL, WINDOW & ROOFING SHALL BE SELECTED BY THE OWNER.
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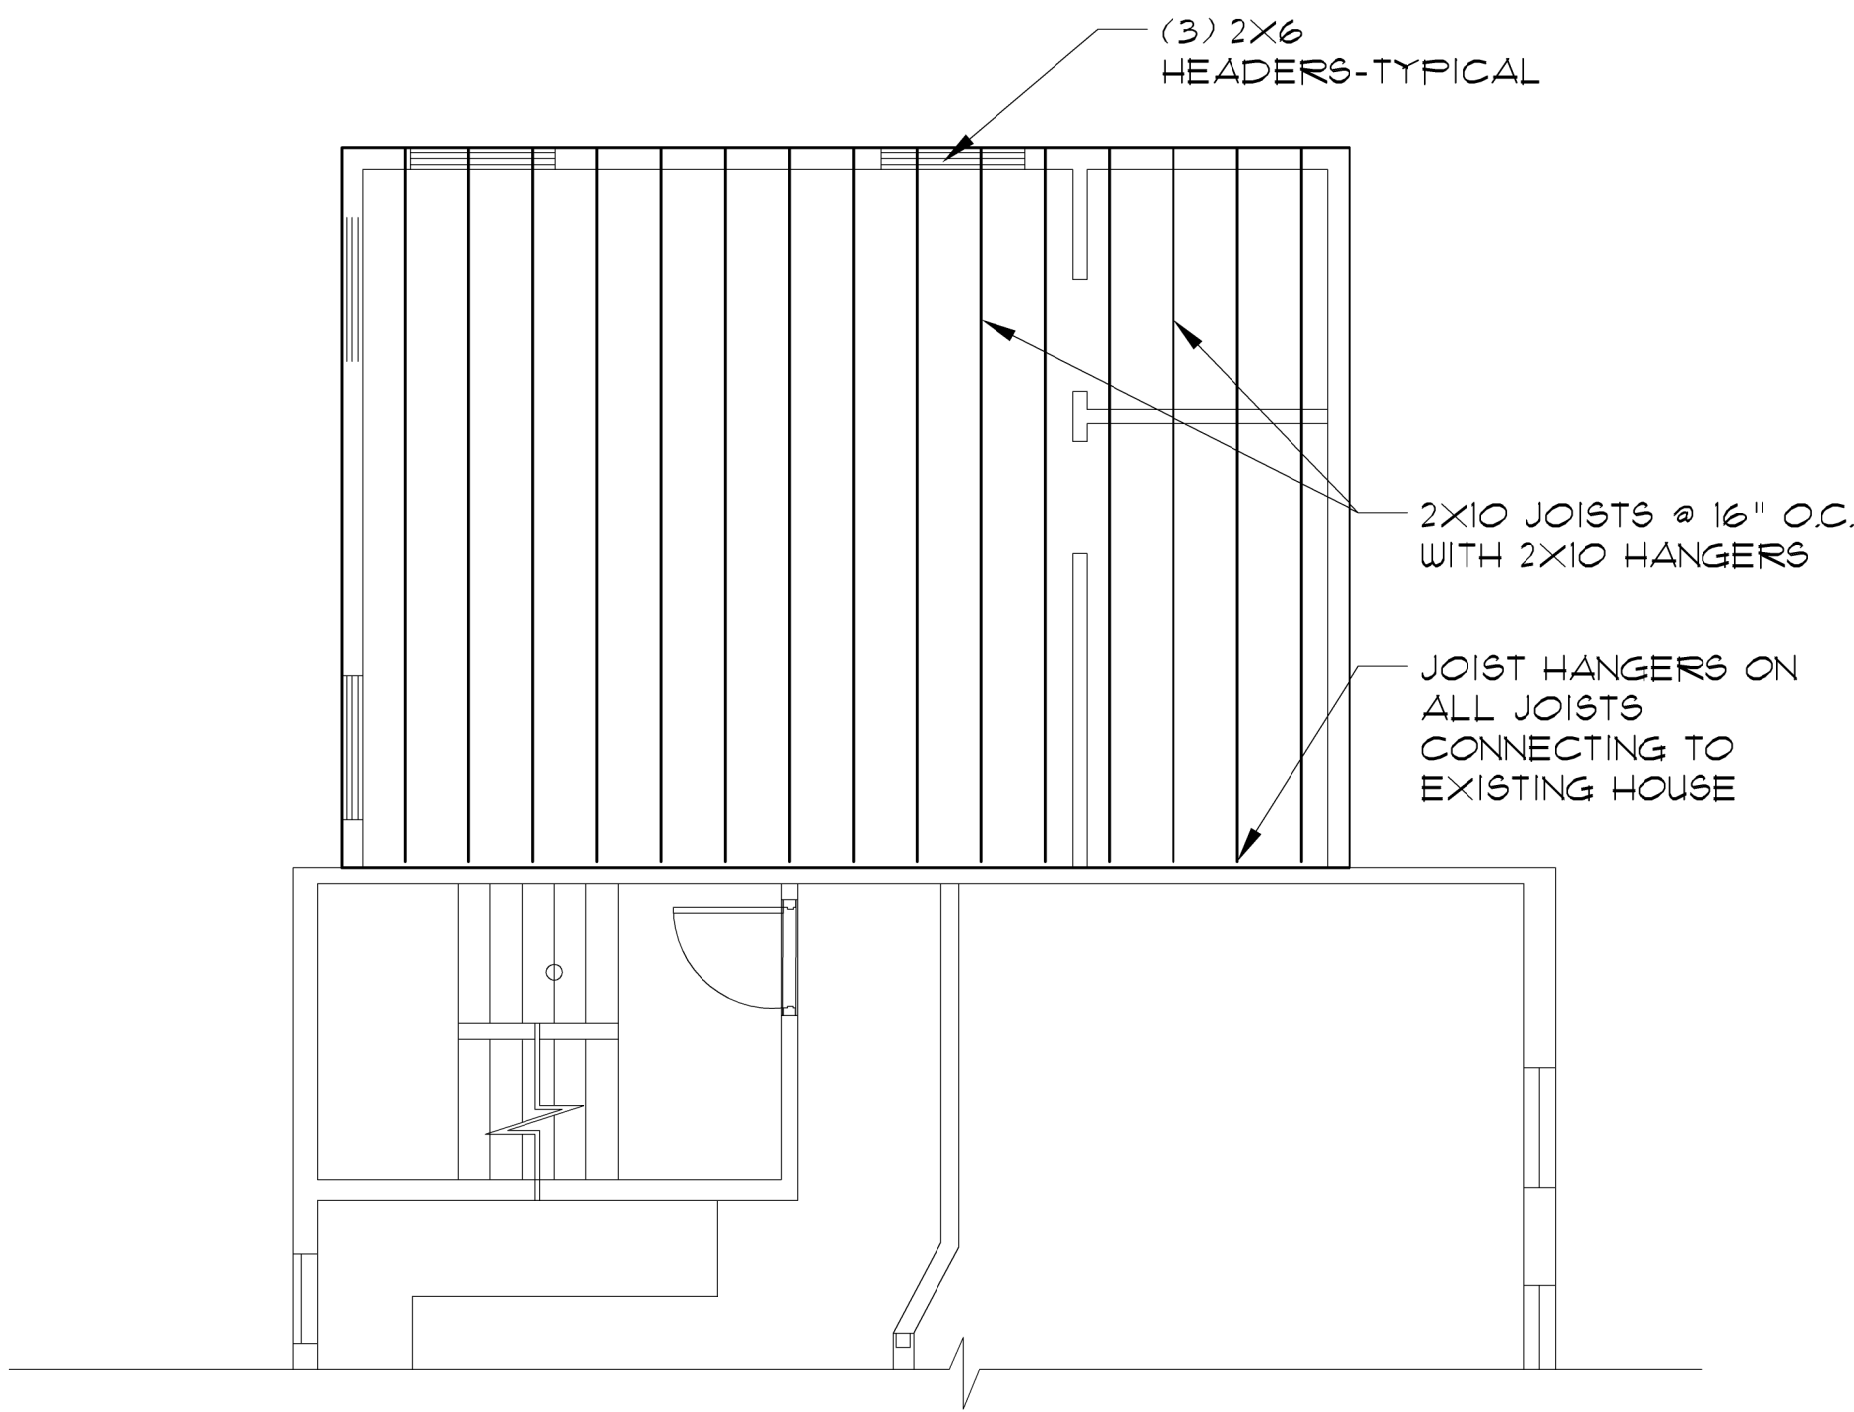
PROPOSED THIRD FLOOR FRAMING PLAN




PROPOSED ROOF FRAMING PLAN

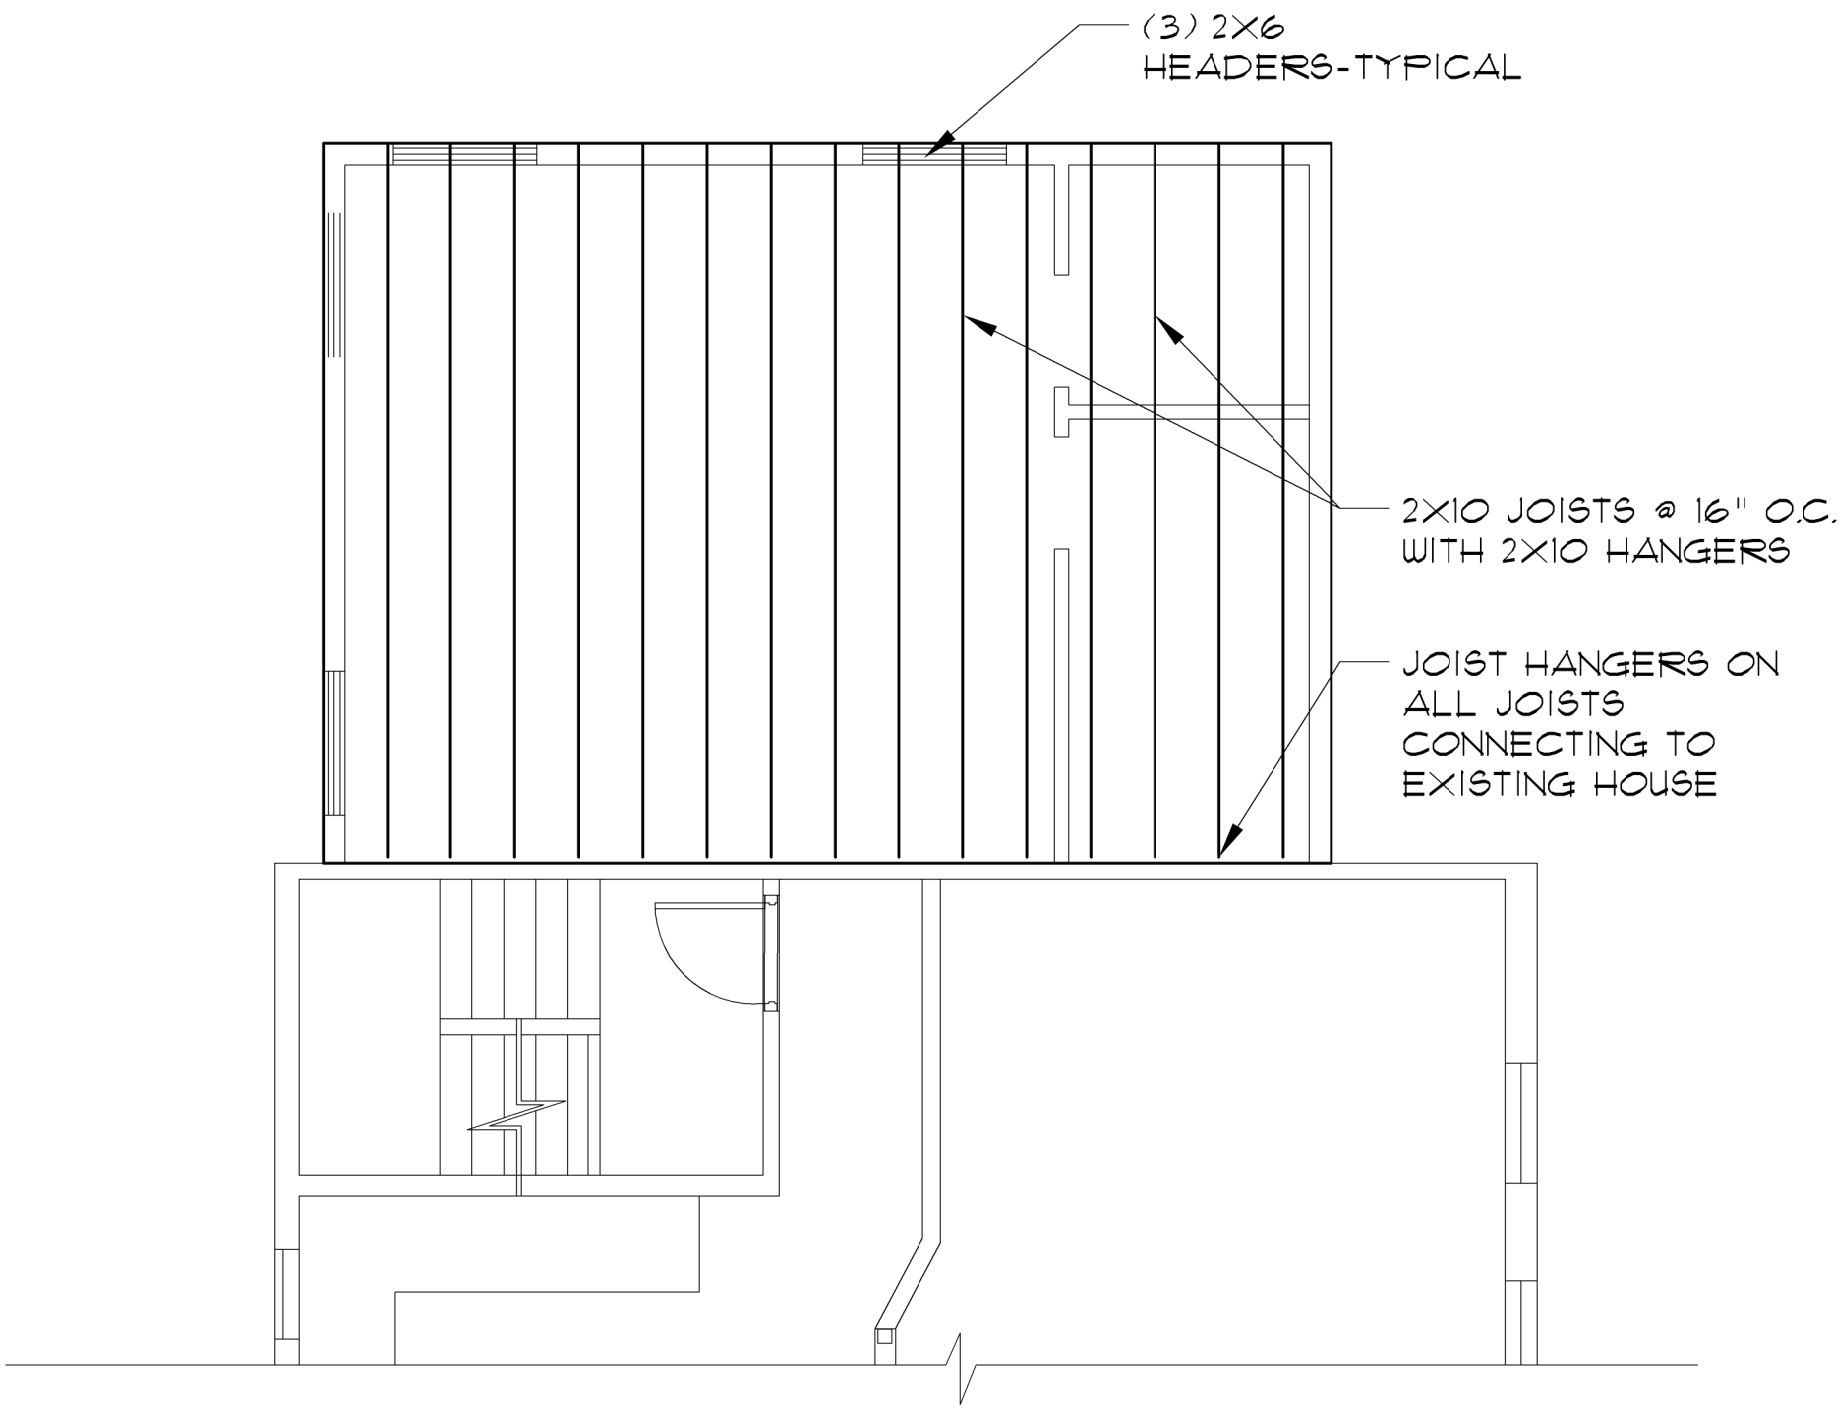

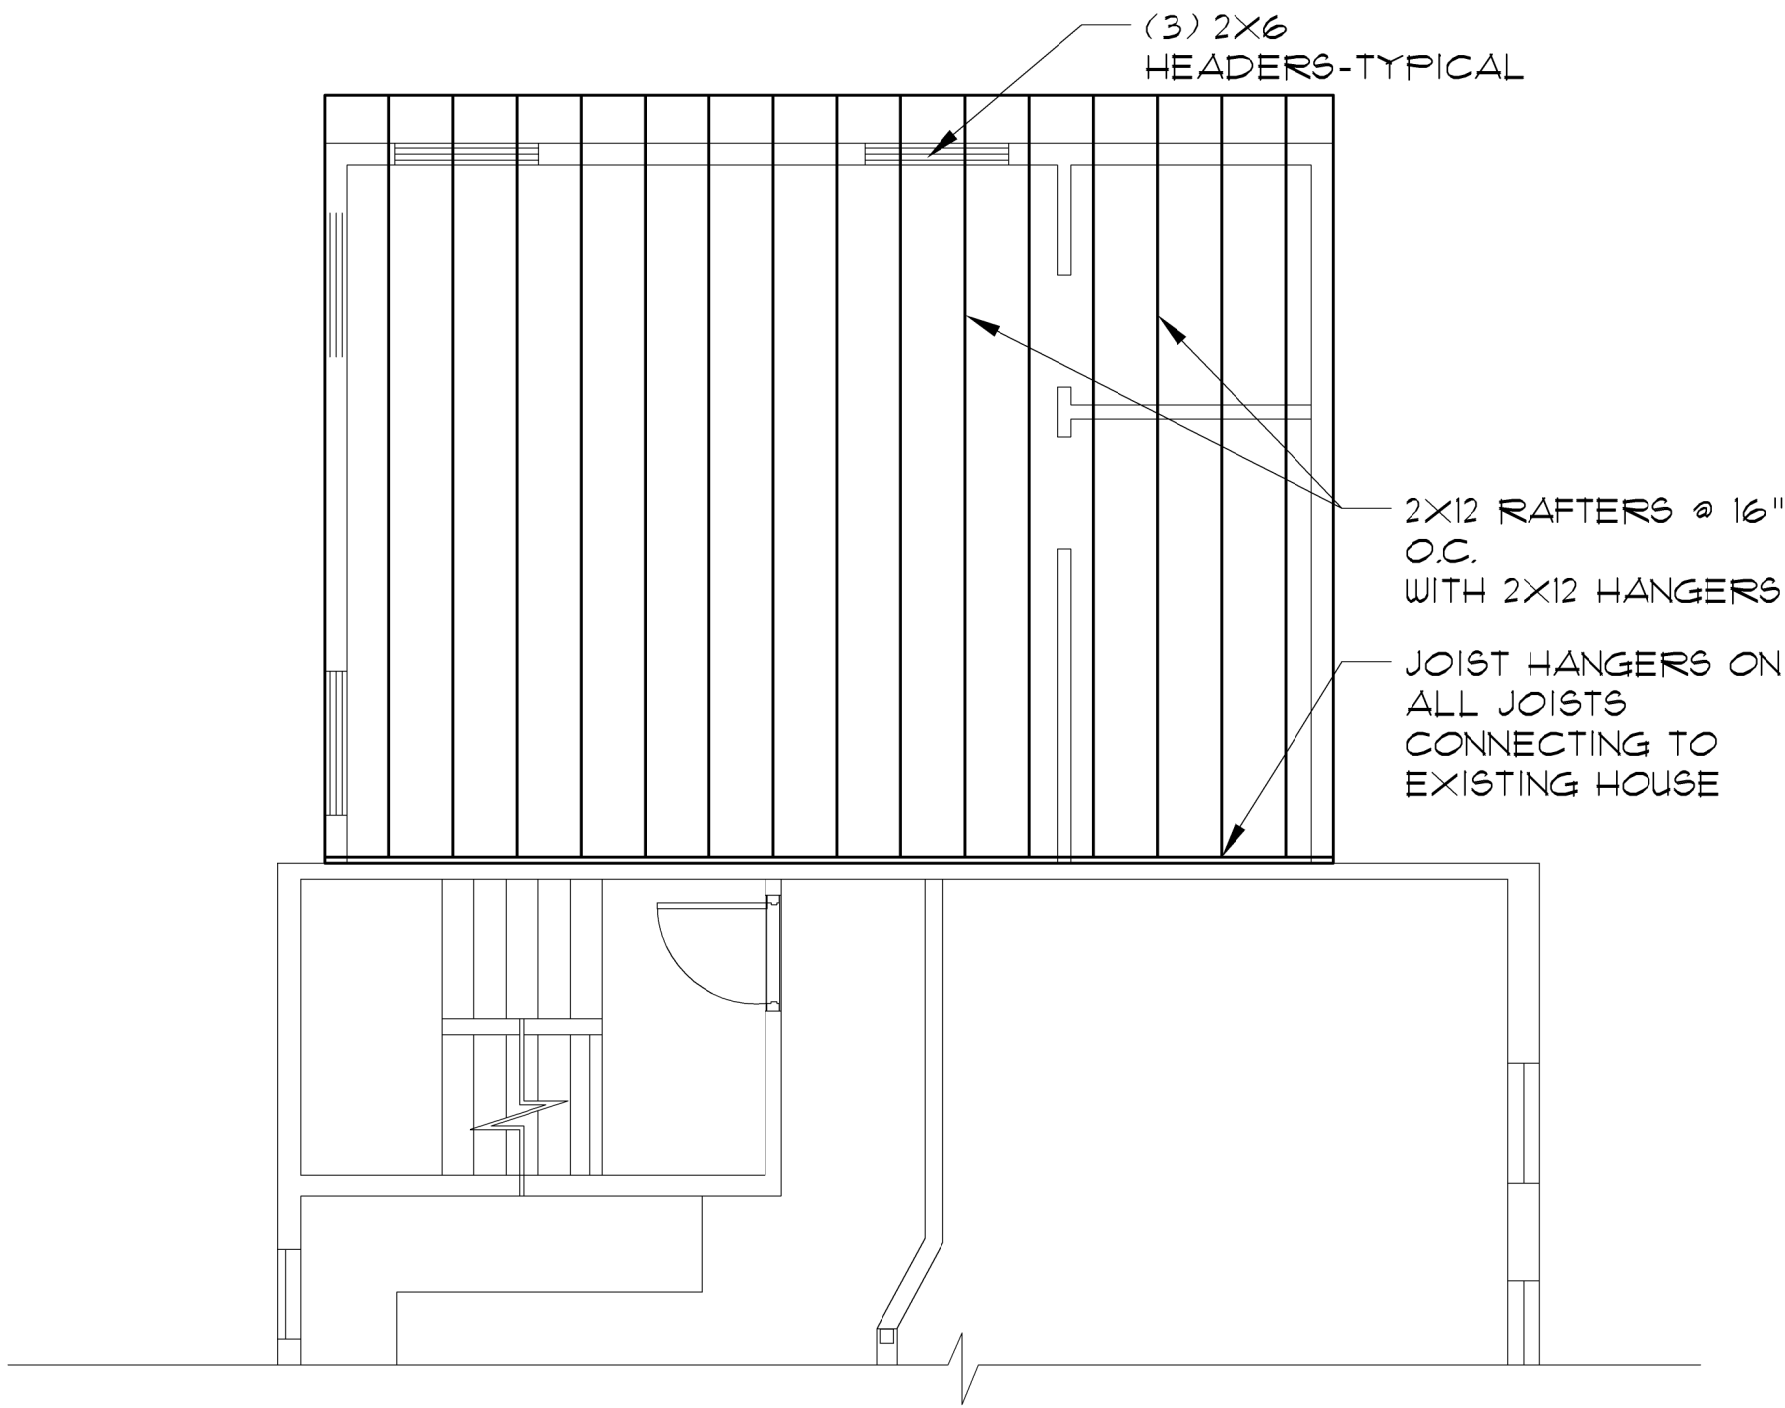PROPOSED FIRST FLOOR FRAMING PLAN

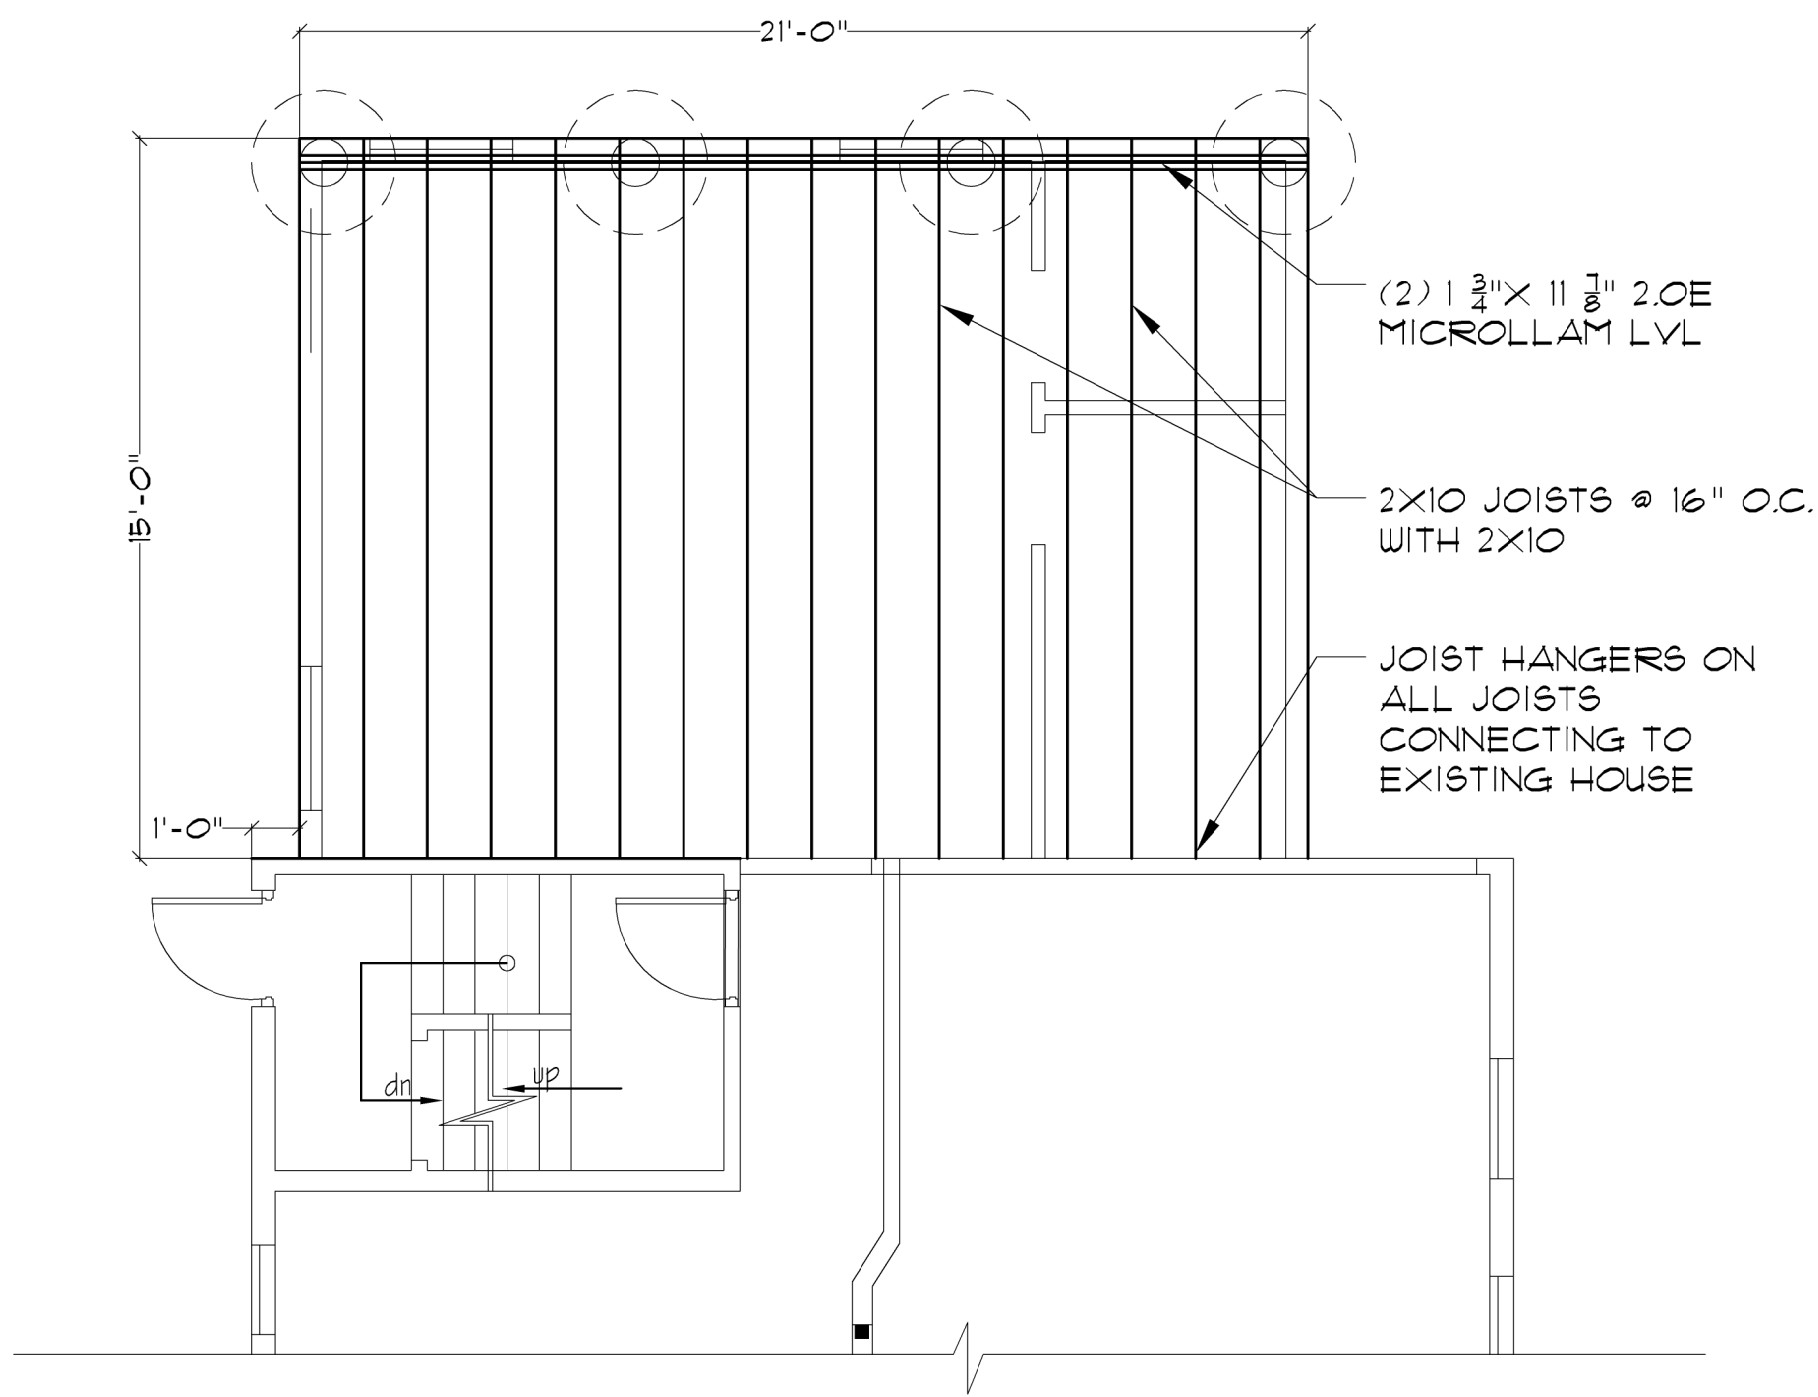


PROPOSED SECOND FLOOR FRAMING PLAN

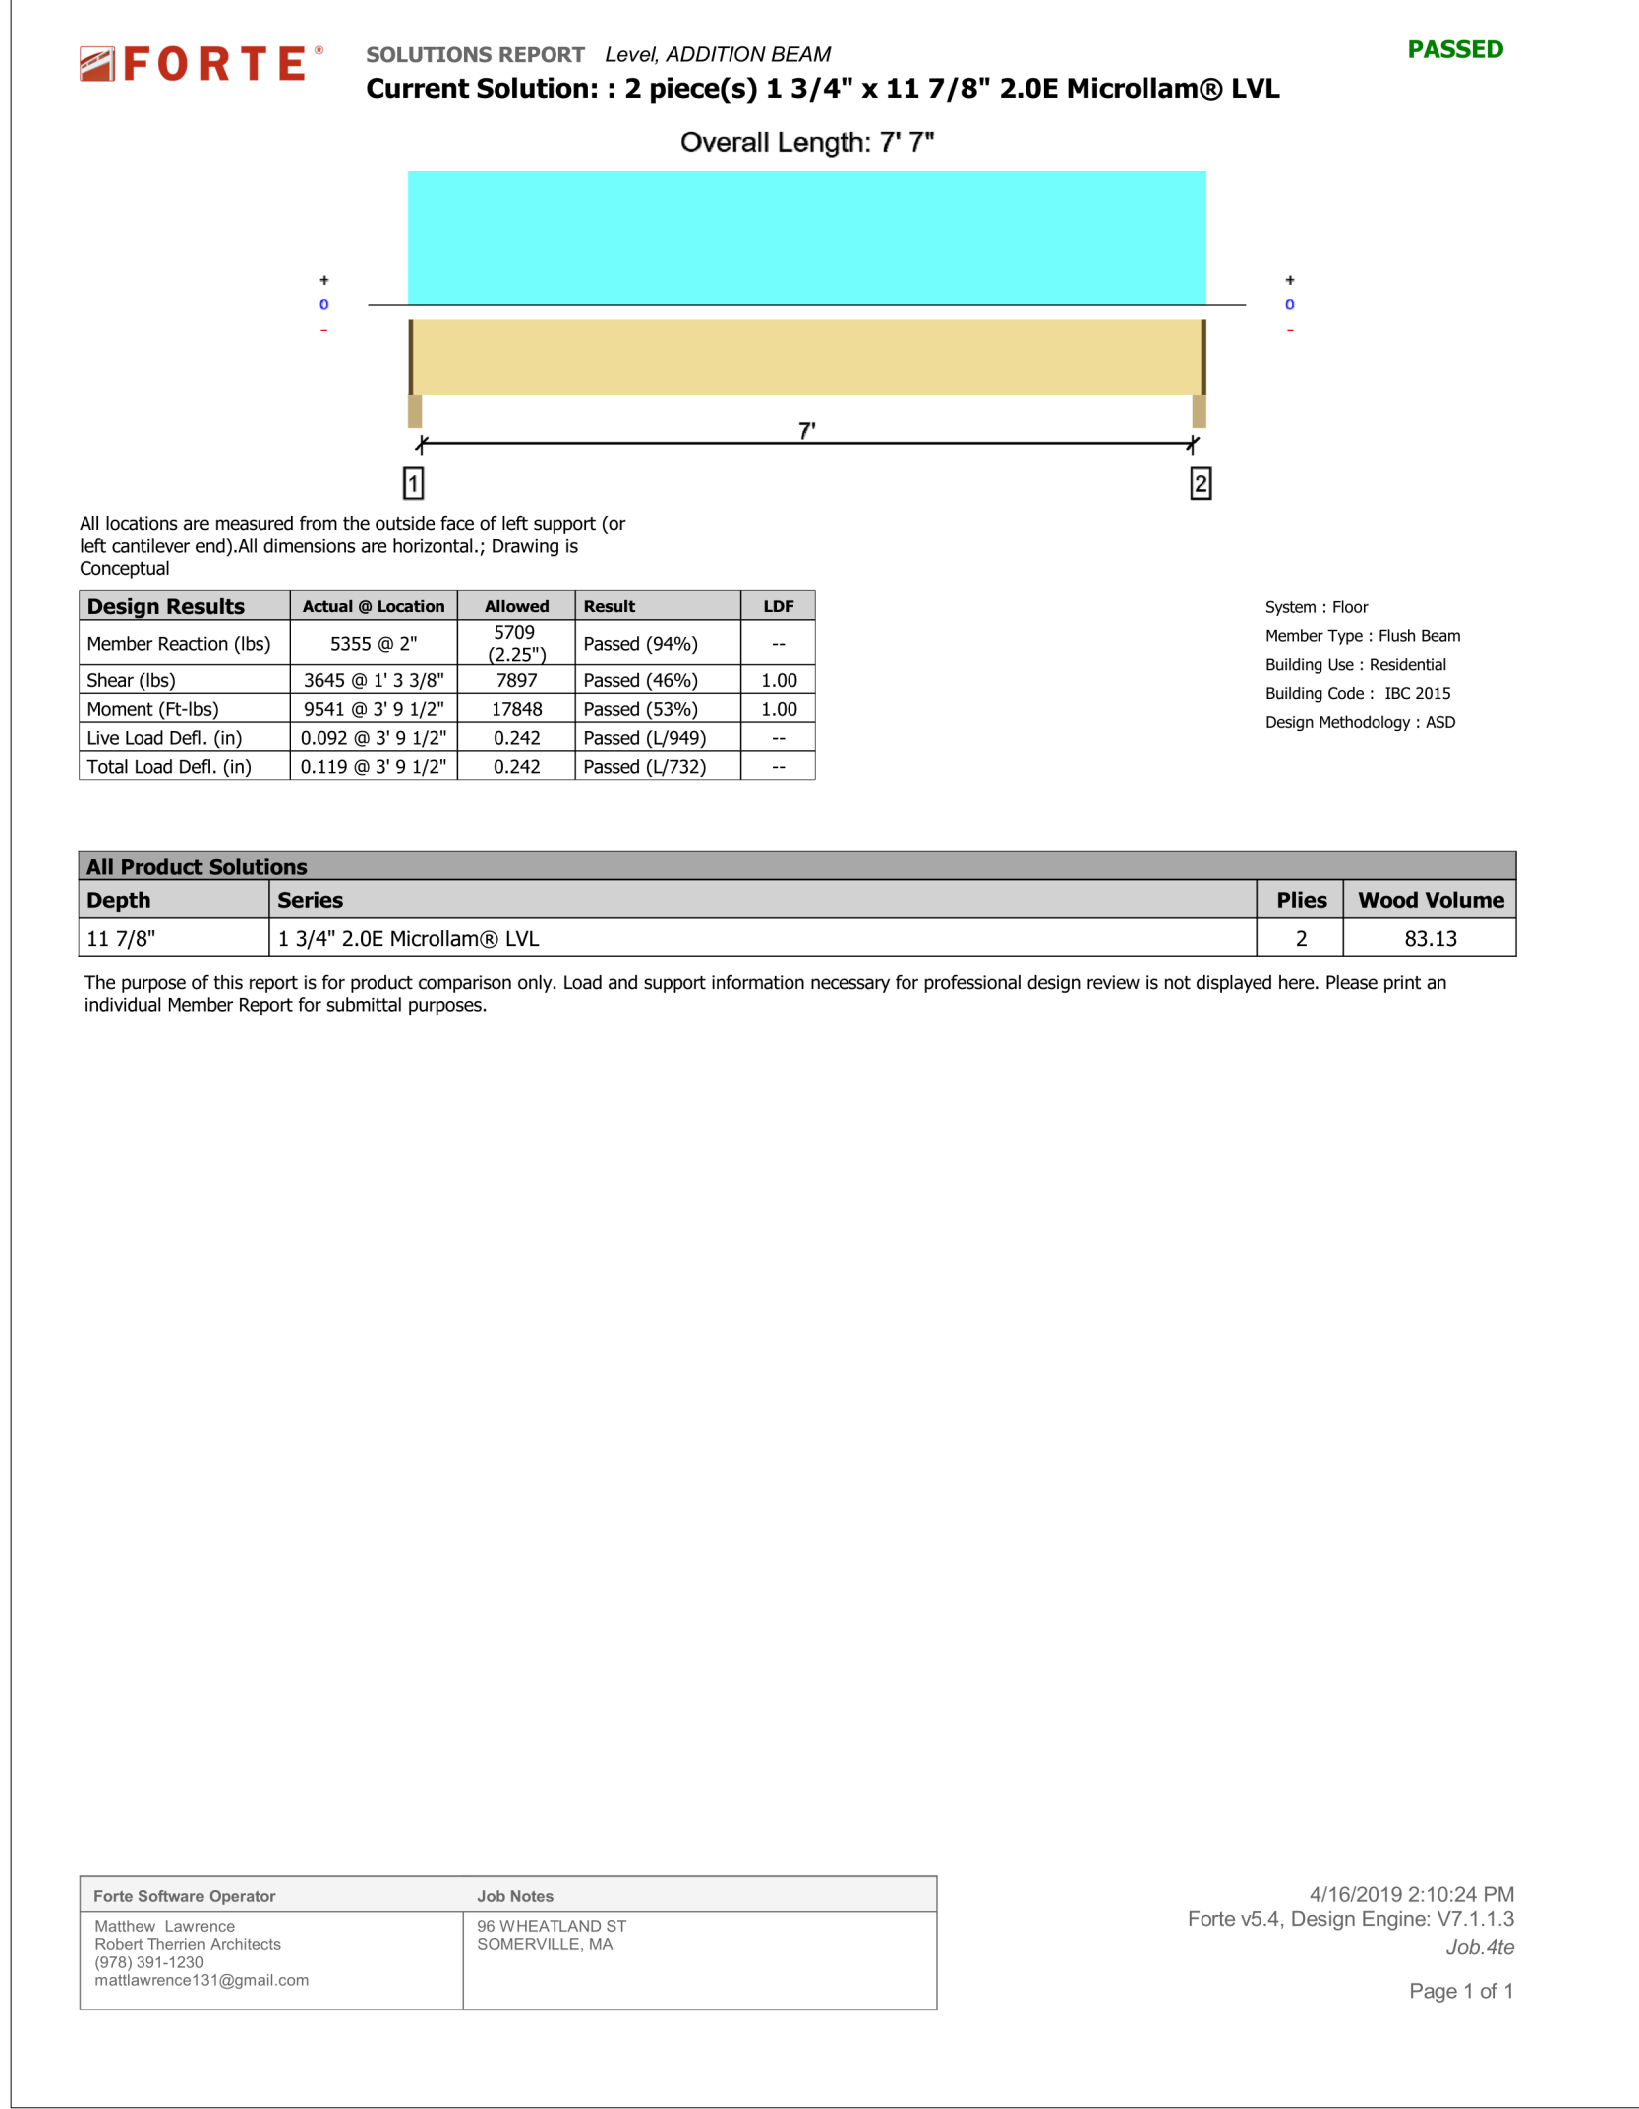

ROBERT THERRIEN, ARCHITECT

249 AYER RD HARVARD, MA 01451

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TITLE:
FRAMING PLANS

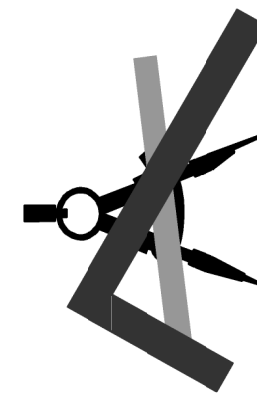
ADDITION & INTERIOR RENOVATION

96 WHEATLAND ST.
SOMERVILLE, MA

COMMISSION NO.
C041019

Sheet

A6

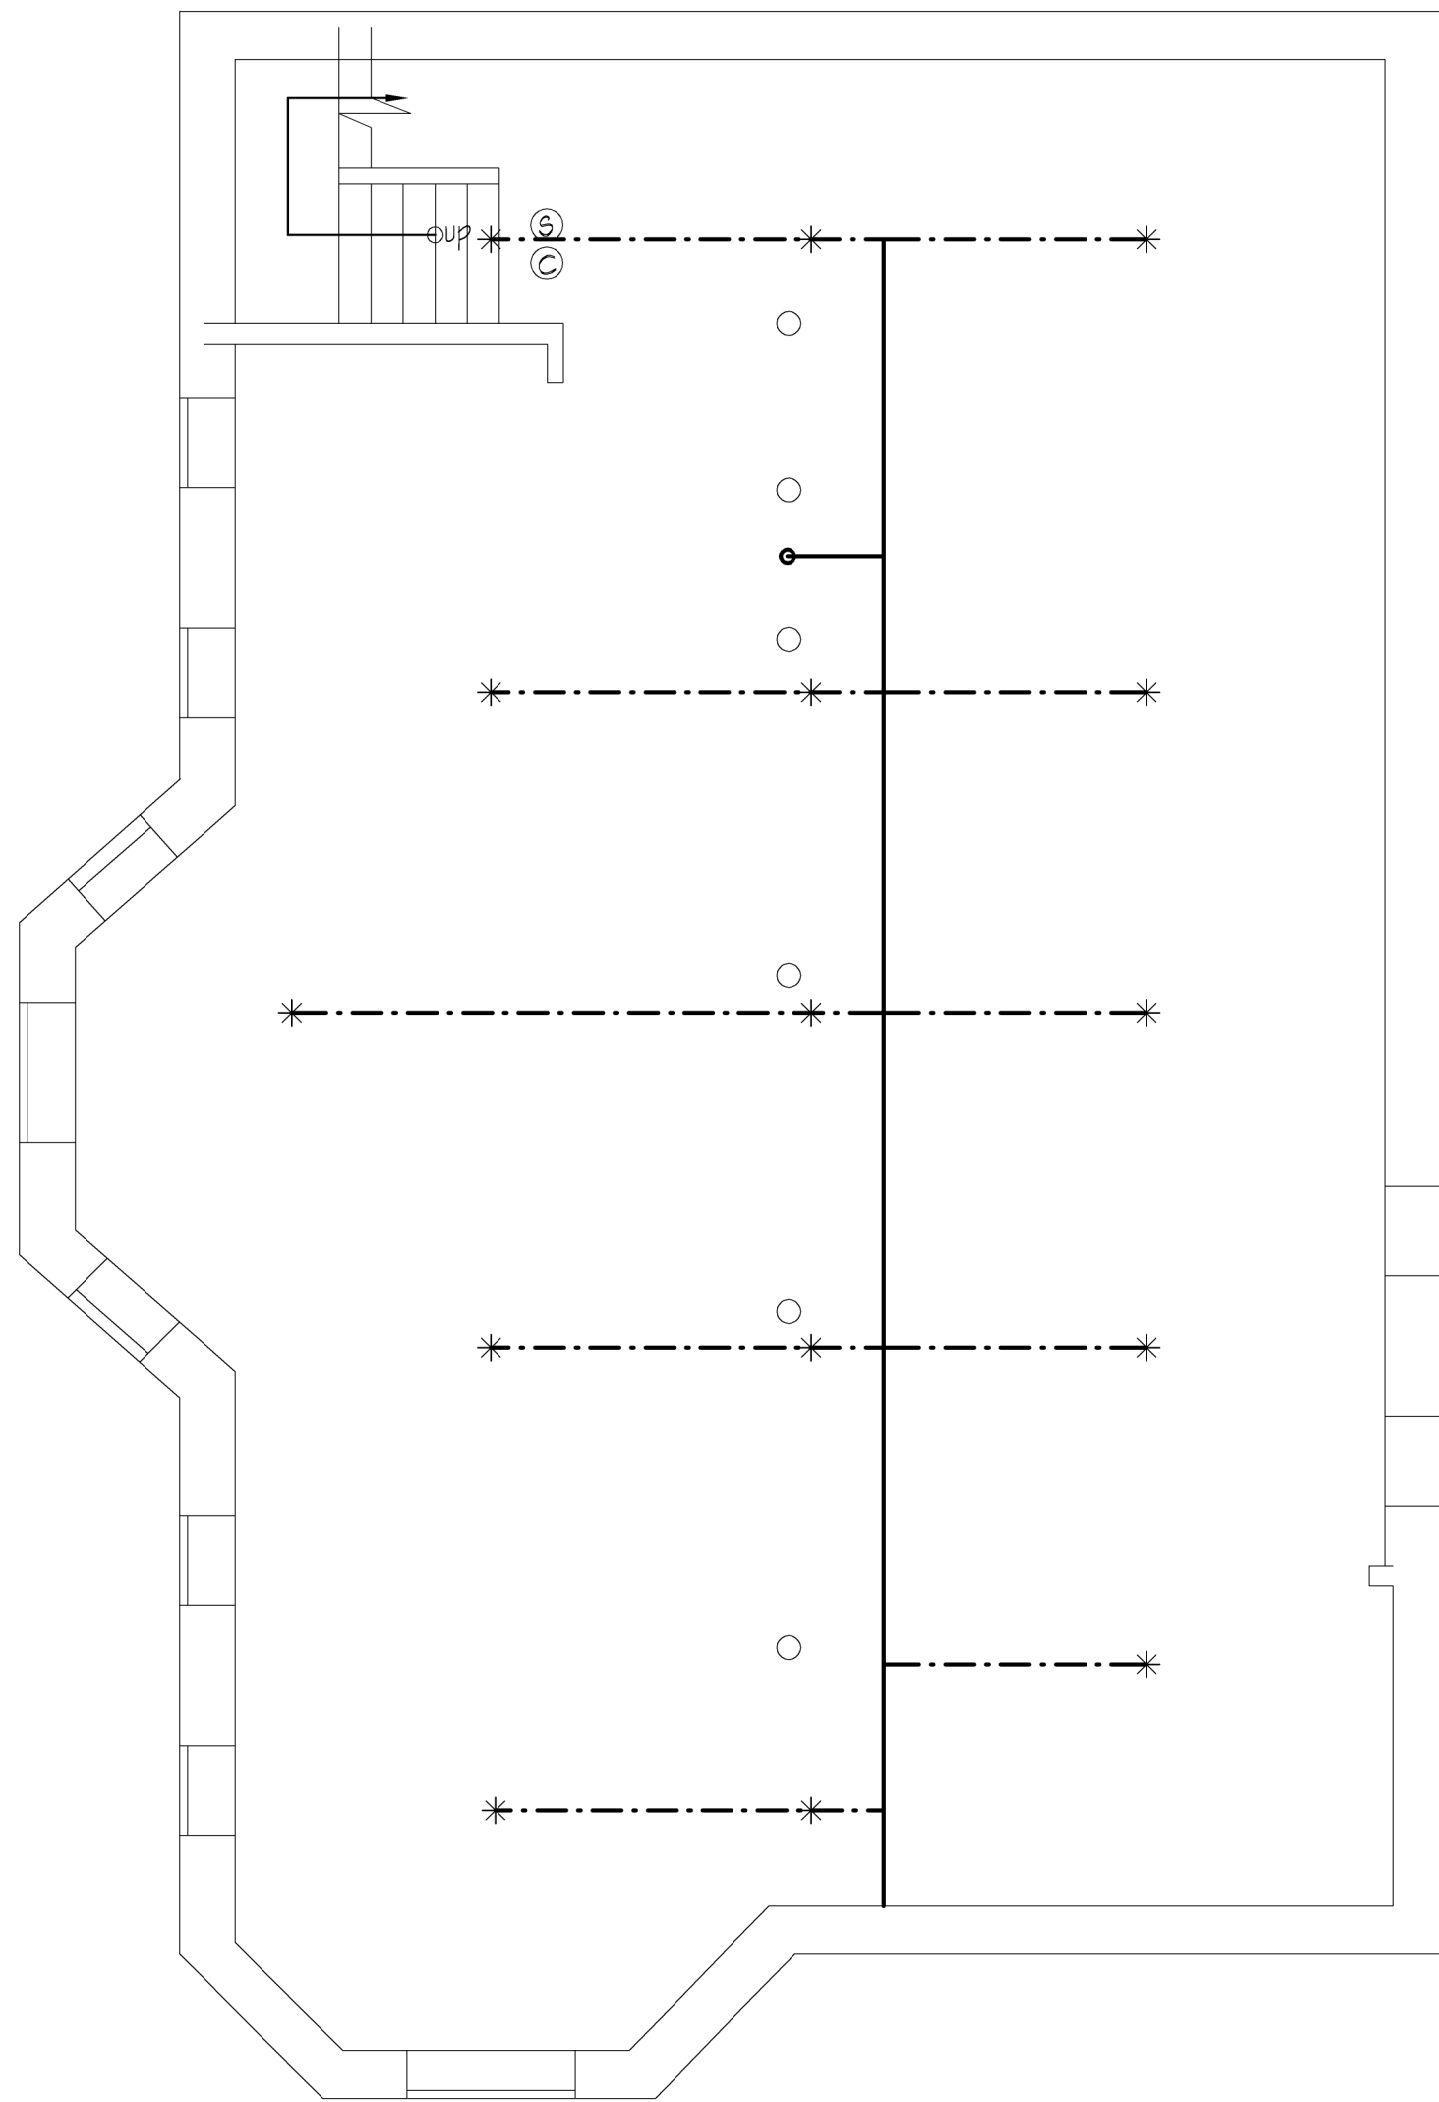

ARCHITECTURAL NOTE

THESE DRAWINGS ARE PREPARED FOR CONCEPTUAL COVERAGE ANALYSIS FOR PURPOSES OF PROVIDING AN AUTOMATIC/DOMESTIC RESIDENTIAL SPRINKLER SYSTEM LINKED TO THE FIRE DETECTION SYSTEM. NFPA CERTIFIED DESIGN LAYOUT IS REQUIRED AND SHALL BE EXECUTED IN ACCORDANCE WITH NFPA REQUIREMENTS.

LEGEND


- MAIN SUPPLY
- - - - - BRANCH LINE
* SPRINKLER HEAD

FIRE ALARM & FIRE PROTECTION SHALL BE INTEGRATED TO PERFORM COLLECTIVELY.

FIRE DETECTION & LIFE SAFETY

- FP FIRE PULL
HORN/STROBE HIGH DECIBEL
BEACON
ANNUNCIATOR
FIRE DEPT. LOCK BOX
SMOKE DETECTOR
CARBON MONOXIDE DETECTOR
EXIT EXIT SIGN
EMERGENCY LIGHTING

NOTE:
ALL FIRE DETECTION SHALL COMPLY WITH STATE & LOCAL CODES.
REFER TO INSTALLER'S RISER DIAGRAM FOR DETAILED INFORMATION.

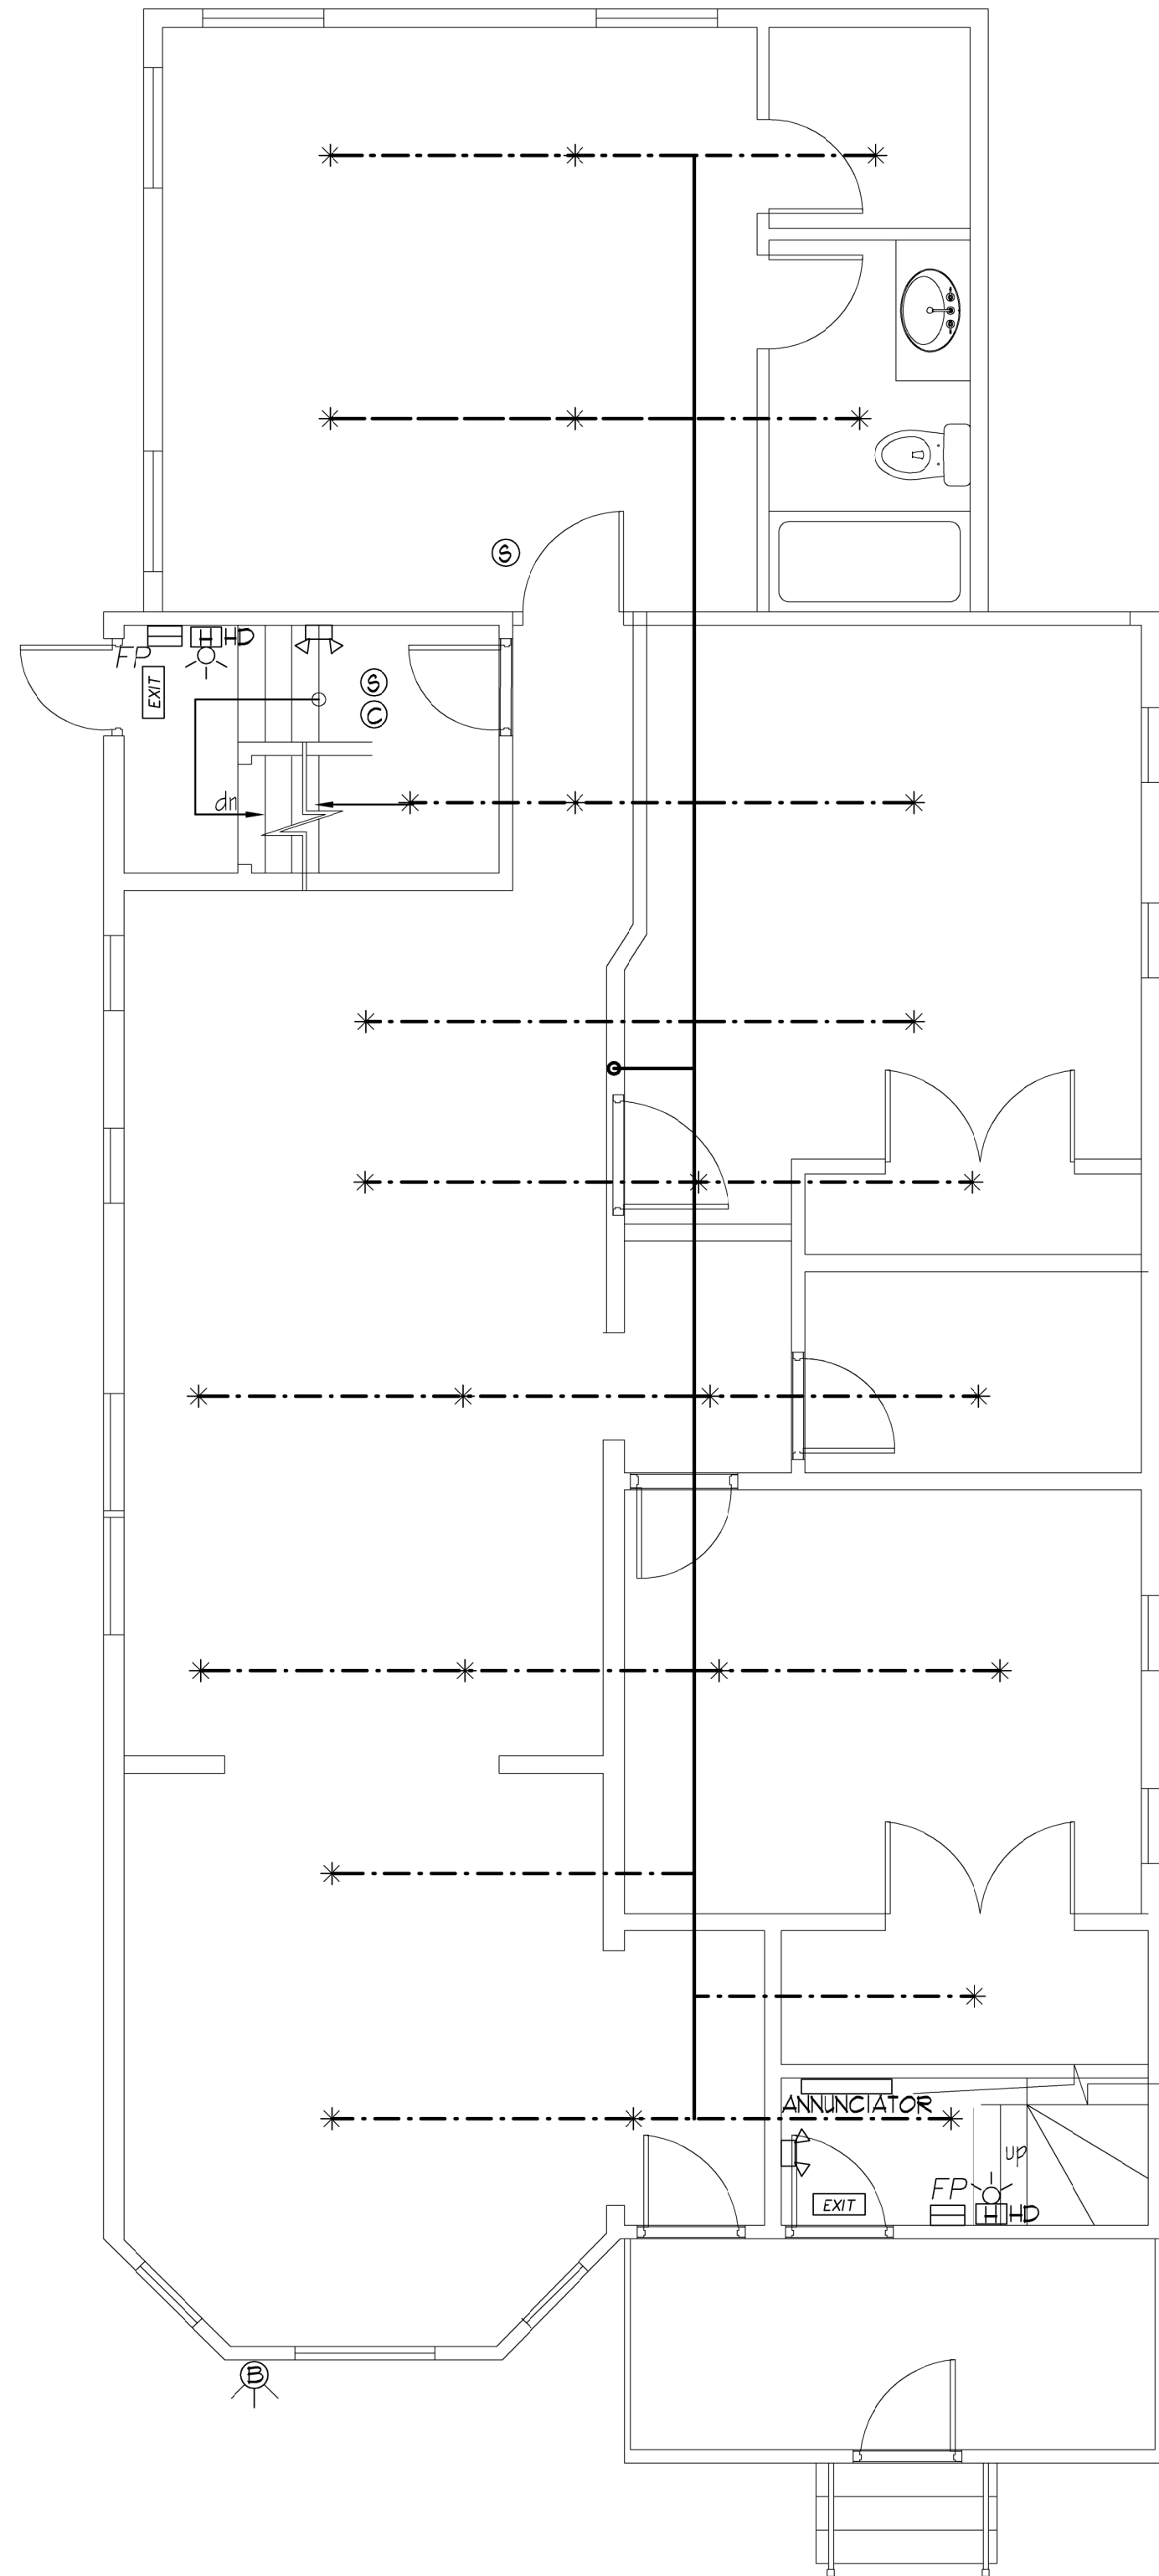

GENERAL NOTES:

1. CONTRACTOR TO VERIFY ALL DIMENSIONS PRIOR TO COMMENCING ANY NEW CONSTRUCTION.
2. CONTRACTOR SHALL VERIFY FLOOR TO FLOOR HEIGHTS PRIOR TO COMMENCING CONSTRUCTION.
3. CONTRACTOR SHALL REPORT ANY DISCREPANCIES TO THE ARCHITECT FOR INSTRUCTION.
4. ALL WORK TO BE EXECUTED IN ACCORDANCE WITH STATE AND LOCAL CODES AND INDUSTRY STANDARD CONSTRUCTION REQUIREMENTS.
5. INSULATION REQUIREMENTS WERE PREPARED IN ACCORDANCE WITH STATE BUILDING CODE. MANY COMMUNITIES HAVE INCREASED THESE REQUIREMENTS BY ADOPTING "ENERGY STRETCH CODE". CHECK WITH LOCAL BUILDING DEPARTMENT REGARDING THESE REQUIREMENTS, EXCEPTIONS, AND WAIVERS.

ARCHITECT'S NOTES:


1. THESE DRAWINGS WERE PREPARED FOR BUILDING PERMIT PURPOSES.
2. OTHER BUILDING SYSTEMS SUCH AS: MECHANICAL, ELECTRICAL, PLUMBING, EXTERIOR FINISHES, HANDRAIL, WINDOW & ROOFING SHALL BE SELECTED BY THE OWNER.
3. ALL OWNER SELECTED SYSTEMS SHALL BE INSTALLED PER MANUFACTURER'S SPECIFICATIONS & COORDINATED WITH THESE DRAWINGS.

CONCEPTUAL FIRST FLOOR SPRINKLER PLAN
DOMESTIC FIRE SUPPRESSION SYSTEM

ROBERT THERRIEN, ARCHITECT

249 AYER RD HARVARD, MA 01451

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TITLE:
BASEMENT & FIRST FLOOR SPRINKLER PLAN

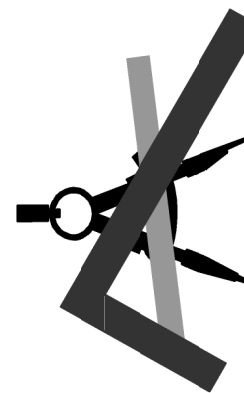ADDITION & INTERIOR RENOVATION

96 WHEATLAND ST.
SOMERVILLE, MA

COMMISSION NO.
C041019

Sheet
SP1

REVISIONS

BY

SCALE:
3/4" = 1'-0"
OR AS NOTED


DRAWN BY:

N.R.L.

CHECKED BY:

R.H.T.

DATE:
5-30-19

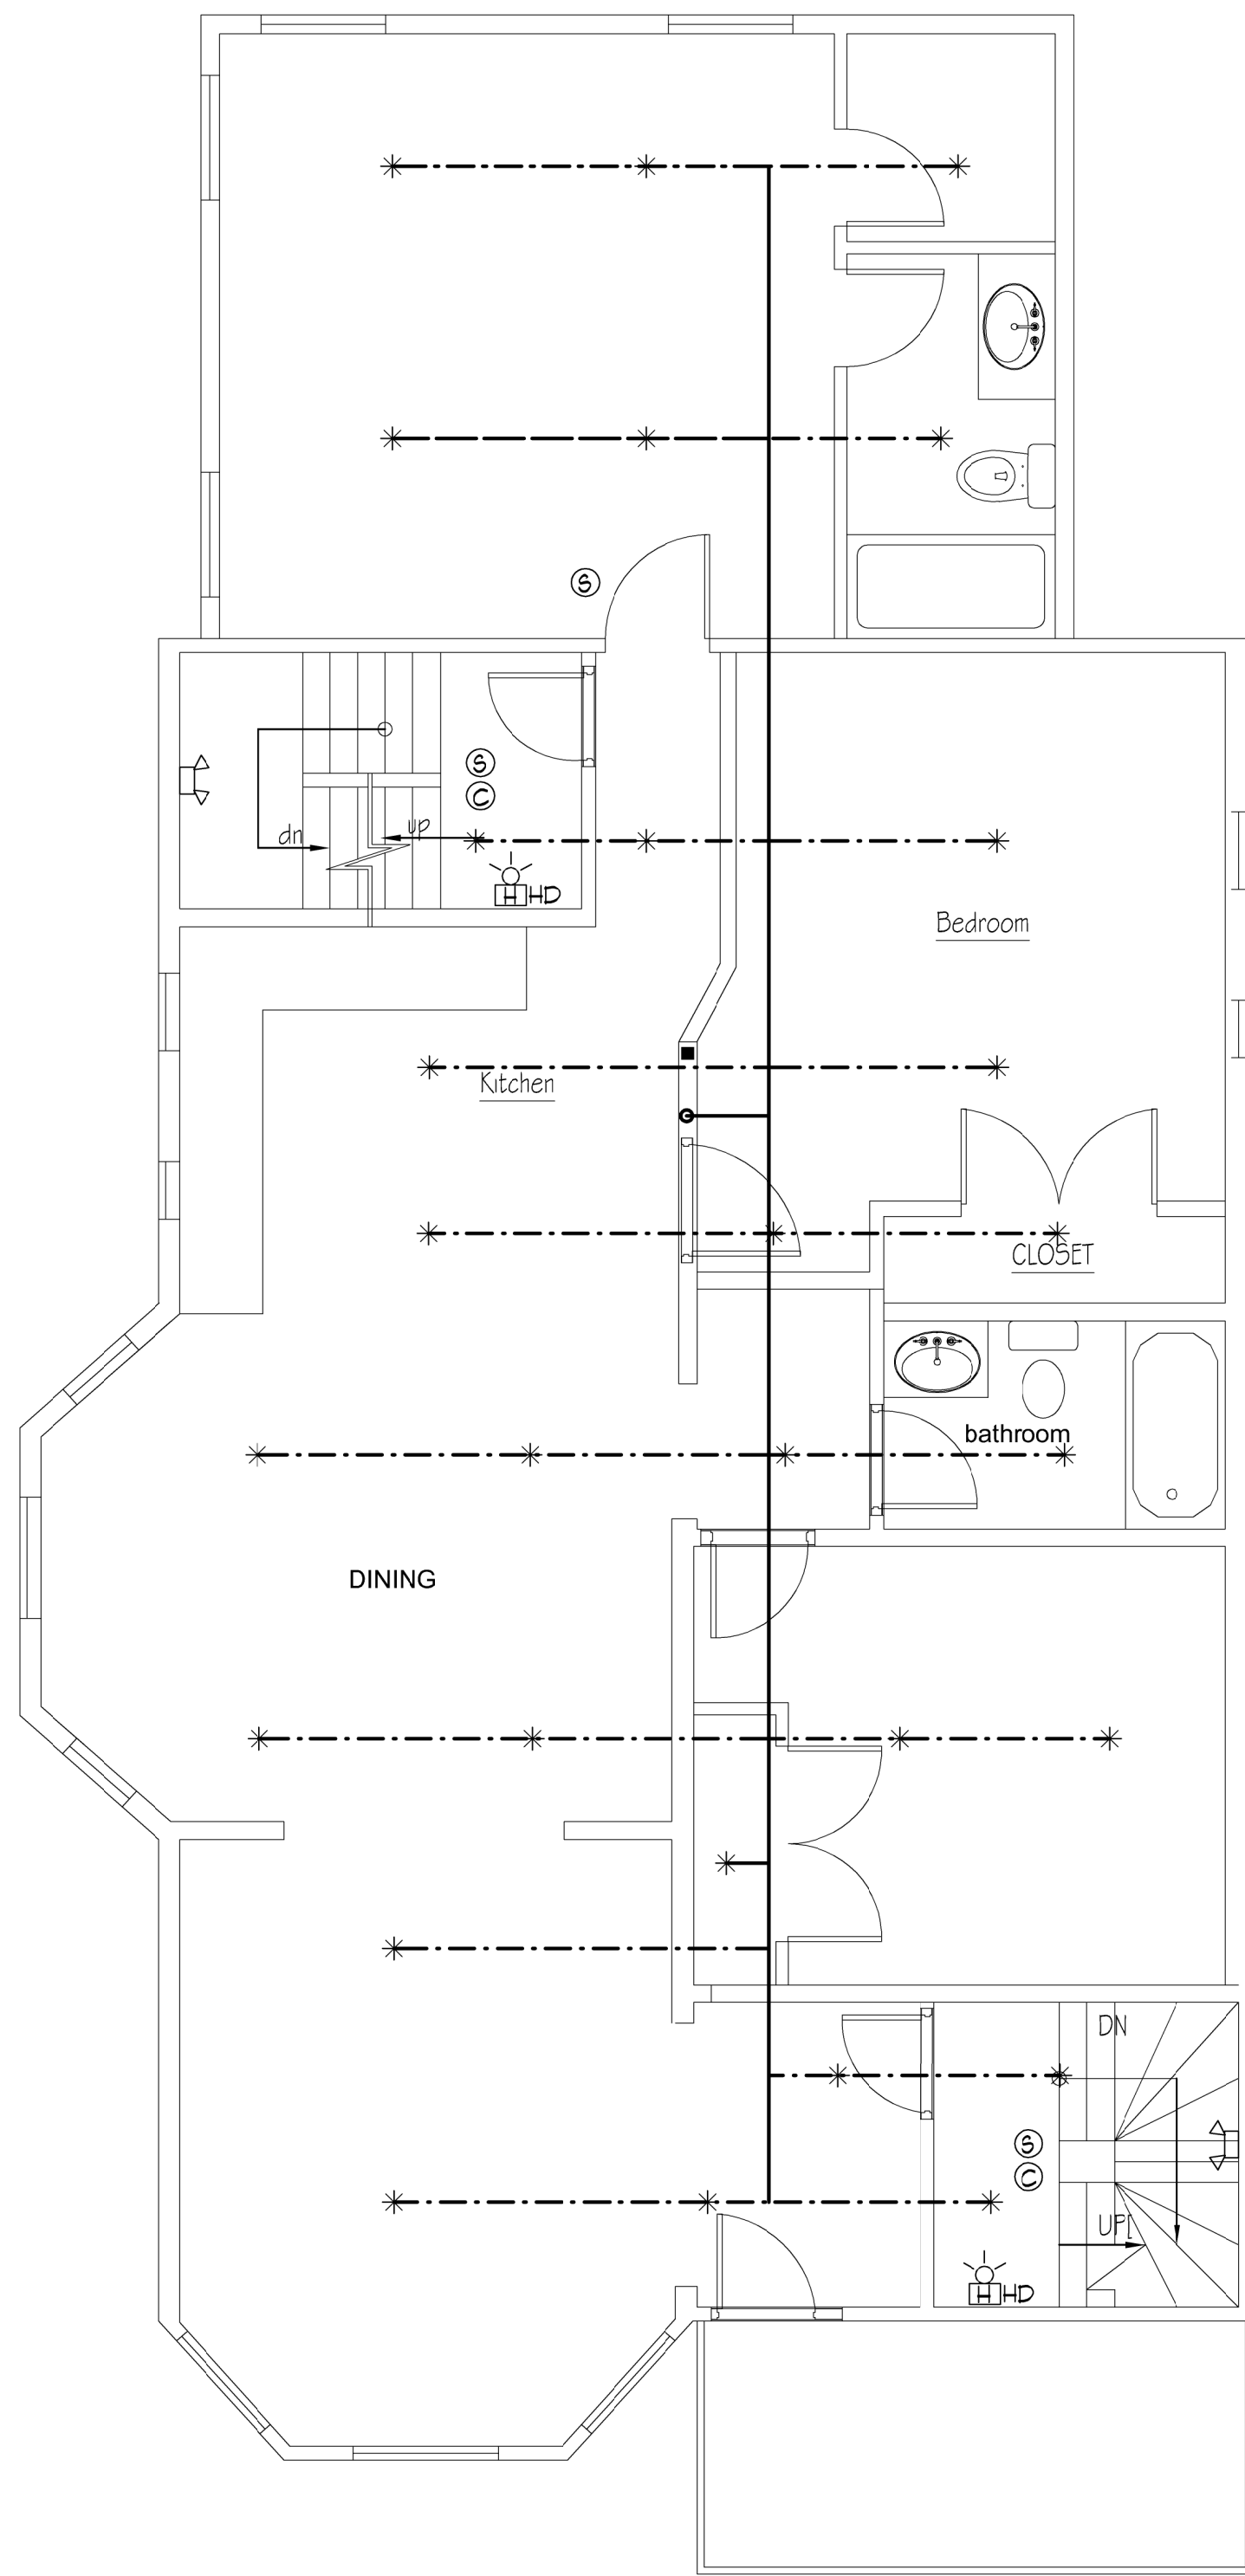

CONCEPTUAL SECOND FLOOR SPRINKLER PLAN
DOMESTIC FIRE SUPPRESSION SYSTEM

FIRE DETECTION & LIFE SAFETY

FP FIRE PULL

HS HD HORN/STROBE HIGH DECIBEL

B BEACON

ANNUNCIATOR

FDL FIRE DEPT. LOCK BOX


S SMOKE DETECTOR

C CARBON MONOXIDE DETECTOR

EXIT EXIT SIGN

EL EMERGENCY LIGHTING

NOTE:
ALL FIRE DETECTION SHALL COMPLY WITH STATE & LOCAL CODES.
REFER TO INSTALLER'S RISER DIAGRAM FOR DETAILED INFORMATION.

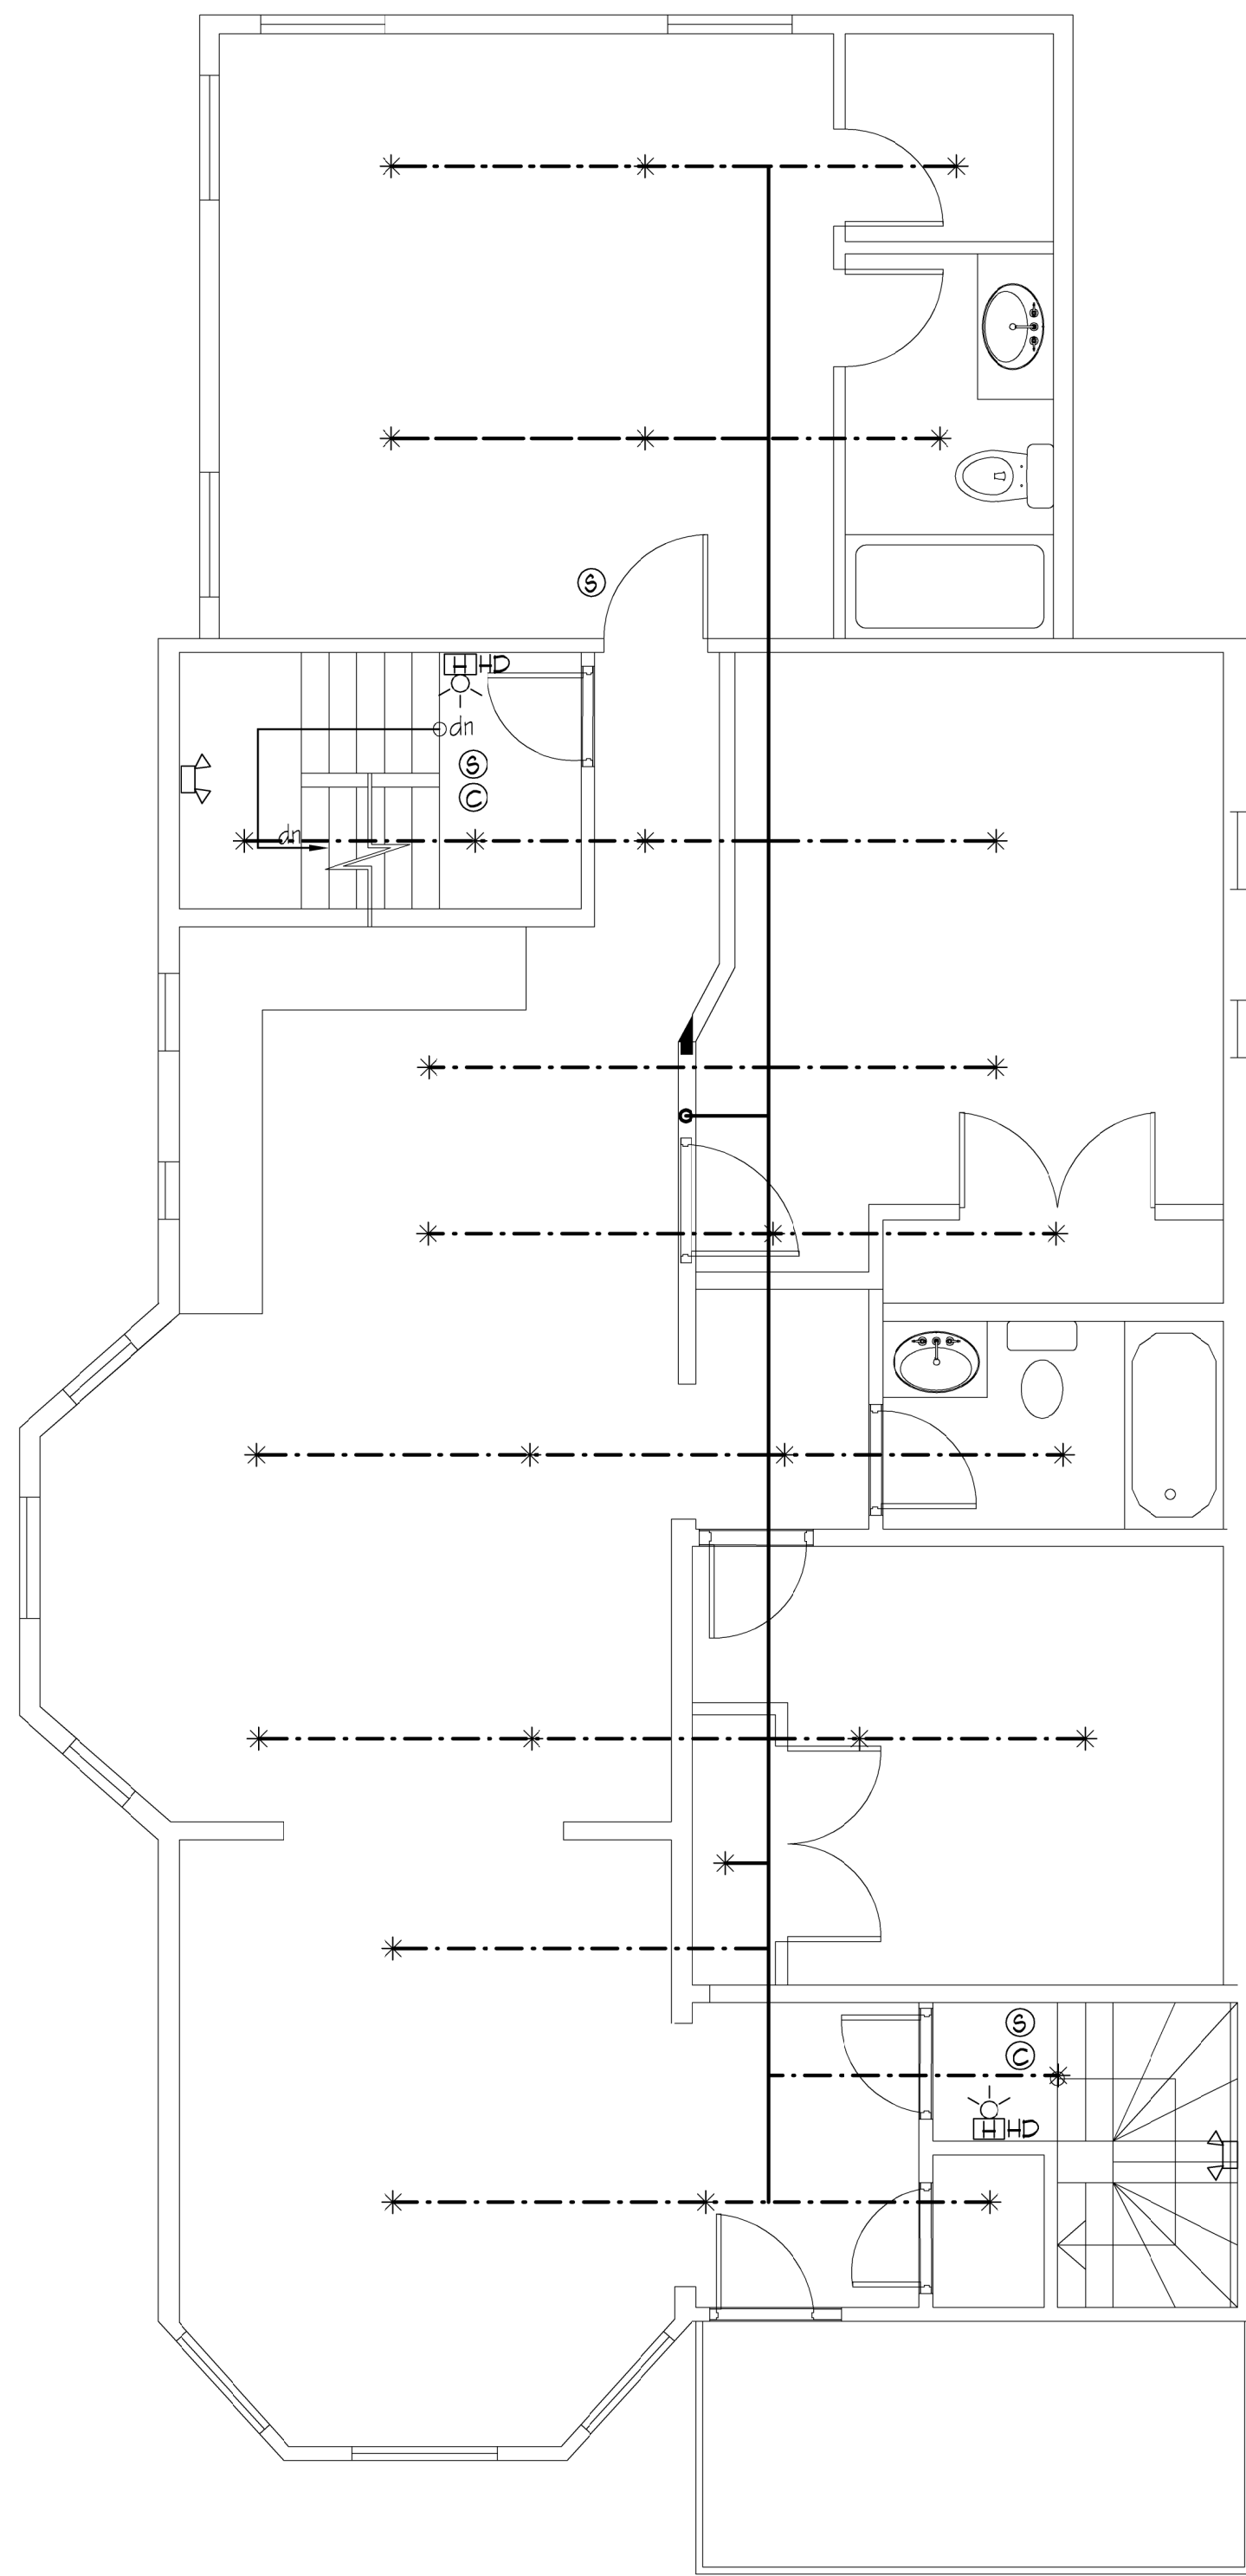

CONCEPTUAL THIRD FLOOR SPRINKLER PLAN
DOMESTIC FIRE SUPPRESSION SYSTEM

GENERAL NOTES:
1. CONTRACTOR SHALL VERIFY ALL DIMENSIONS PRIOR TO COMMENCING ANY NEW CONSTRUCTION.
2. CONTRACTOR SHALL VERIFY FLOOR TO FLOOR HEIGHTS PRIOR TO COMMENCING CONSTRUCTION.
3. CONTRACTOR SHALL REPORT ANY DISCREPANCIES TO THE ARCHITECT FOR INSTRUCTION.
4. ALL WORK TO BE EXECUTED IN ACCORDANCE WITH STATE AND LOCAL CODES AND INDUSTRY STANDARD CONSTRUCTION REQUIREMENTS.
5. INSULATION REQUIREMENTS WERE PREPARED IN ACCORDANCE WITH STATE BUILDING CODE. MANY COMMUNITIES HAVE INCREASED THESE REQUIREMENTS BY ADOPTING "ENERGY STRETCH CODE". CHECK WITH LOCAL BUILDING DEPARTMENT REGARDING THESE REQUIREMENTS, EXCEPTIONS, AND WAIVERS.

ARCHITECT'S NOTES:
1. THESE DRAWINGS WERE PREPARED FOR BUILDING PERMIT PURPOSES.
2. OTHER BUILDING SYSTEMS SUCH AS: MECHANICAL, ELECTRICAL, PLUMBING, EXTERIOR FINISHES, HANDRAIL, WINDOW & ROOFING SHALL BE SELECTED BY THE OWNER.
3. ALL OWNER SELECTED SYSTEMS SHALL BE INSTALLED PER MANUFACTURER'S SPECIFICATIONS & COORDINATED WITH THESE DRAWINGS.

ROBERT THERRIEN, ARCHITECT

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TITLE:
SECOND & THIRD FLOOR SPRINKLER PLAN

ADDITION & INTERIOR RENOVATION

96 WHEATLAND ST.
SOMERVILLE, MA

COMMISSION NO.
C041019

Sheet
SP2

REVISIONS	
SCALE: 1/4" = 1'-0" OR AS NOTED	BY
DRAWN BY: M.R.L.	
CHK'D BY: R.H.T.	
DATE: 5-30-19	

